


Kansas
Department of Agriculture
Division of Water Resources

Stafford Field Office
300 S. Main Street
Stafford, Kansas 67578-1521

Jackie McClaskey, Secretary
David W. Barfield, Chief Engineer
Jeff Lanterman, Water Commissioner

Phone: (620) 234-5311
Fax: (620) 234-6900
www.agriculture.ks.gov
Sam Brownback, Governor

September 14, 2017

Faith Mennonite Church
1403 S. Main St.
South Hutchinson, KS 67505

Re: Pending Application, File No. 49,736

Dear Sir or Madam:


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Sincerely,


Matt Meier
Environmental Scientist
Water Appropriations Program

Enclosure

pc:

SCANNED

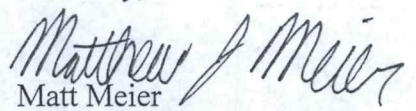
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

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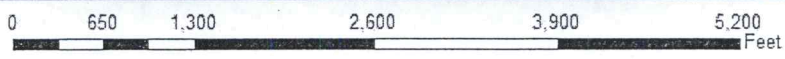
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Legend

-  Section Corners
-  Section Lines

MJM-DWR 9/13/17

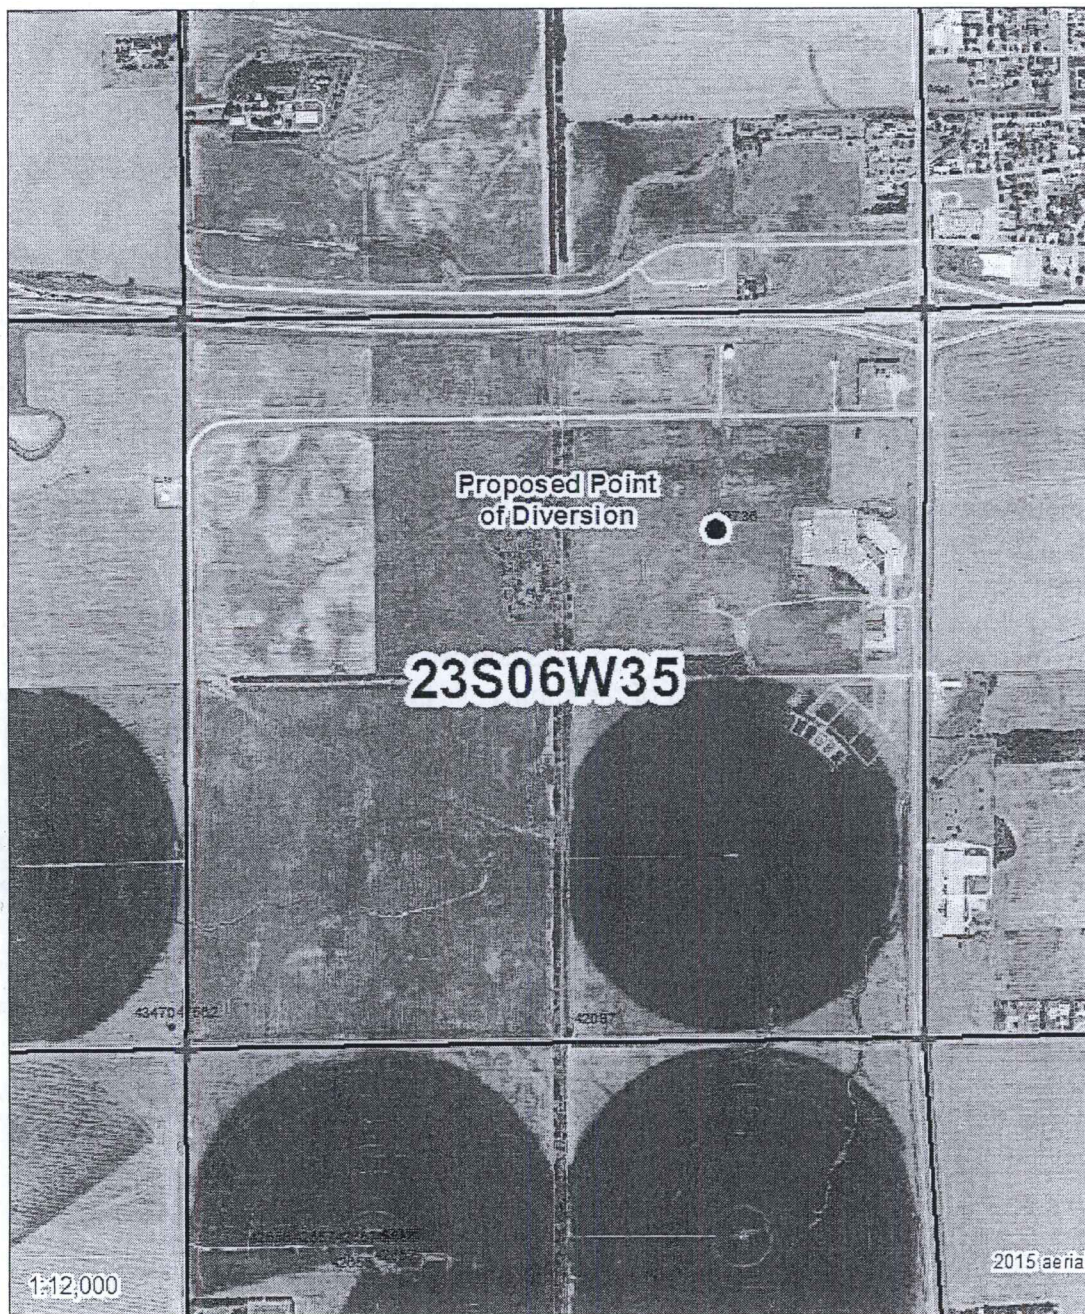

Proposed Water Appropriation, File No. 49736
35-23S-6W
Reno County



SCANNED


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September 14, 2017

CTP LLC
1515 S. Main St.
South Hutchinson, KS 67505

Re: Pending Application, File No. 49,736

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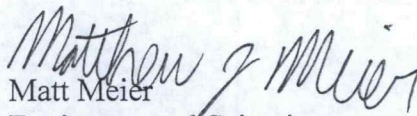
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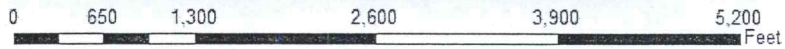
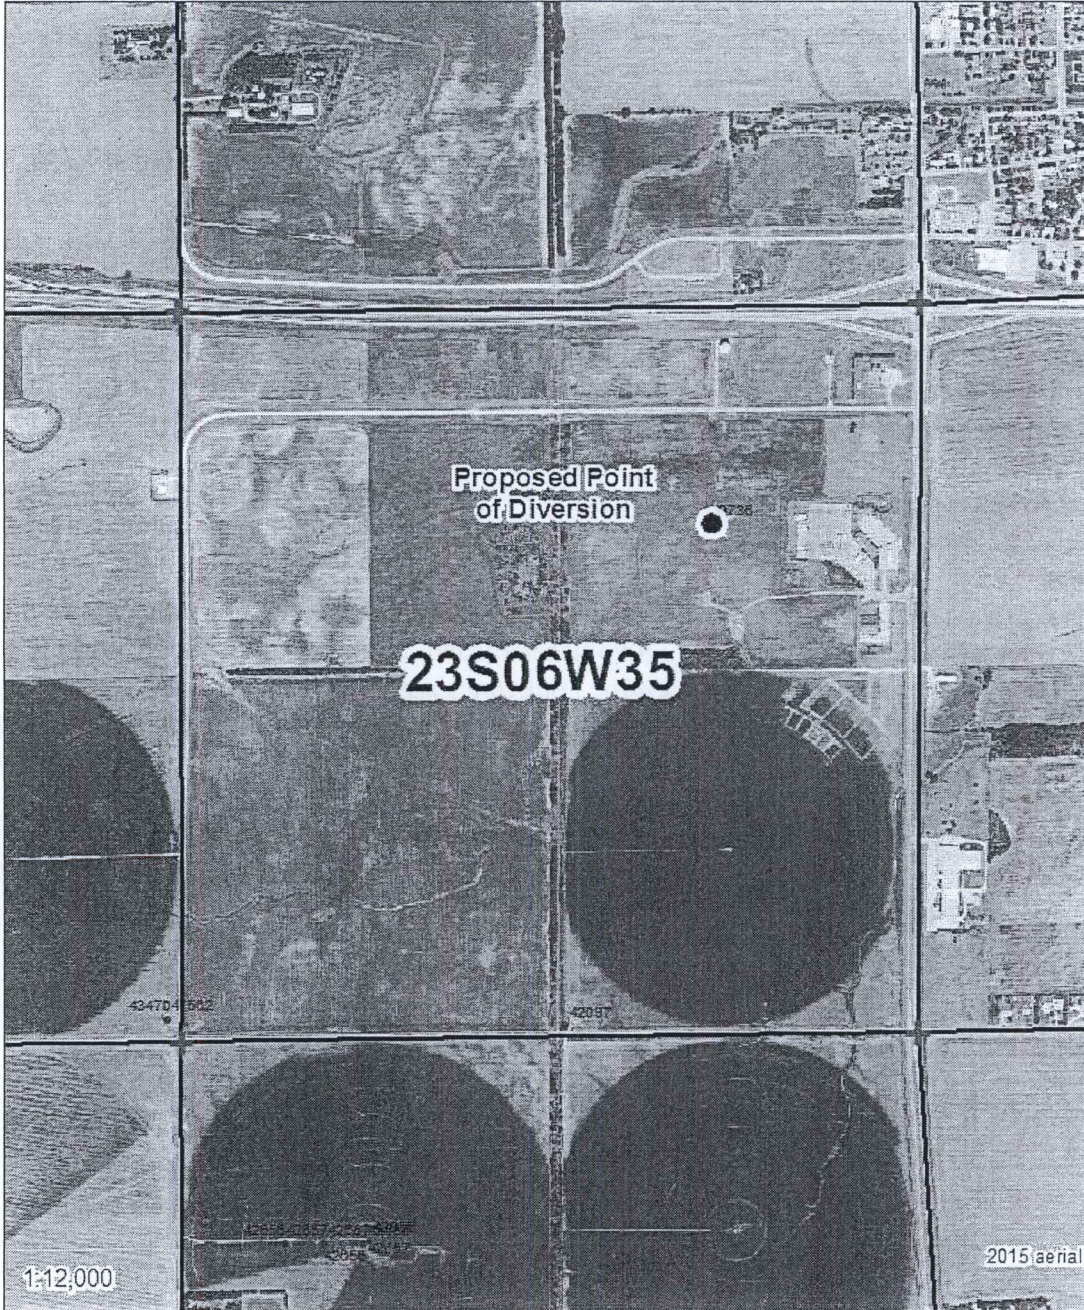
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Legend	
+	Section Corners
—	Section Lines

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September 14, 2017

Larry D Dorskocil Liv Trust
00000 S. K96 Hwy
Hutchinson, KS 67501

Re: Pending Application, File No. 49,736

Dear Sir or Madam:


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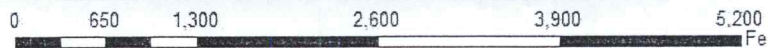
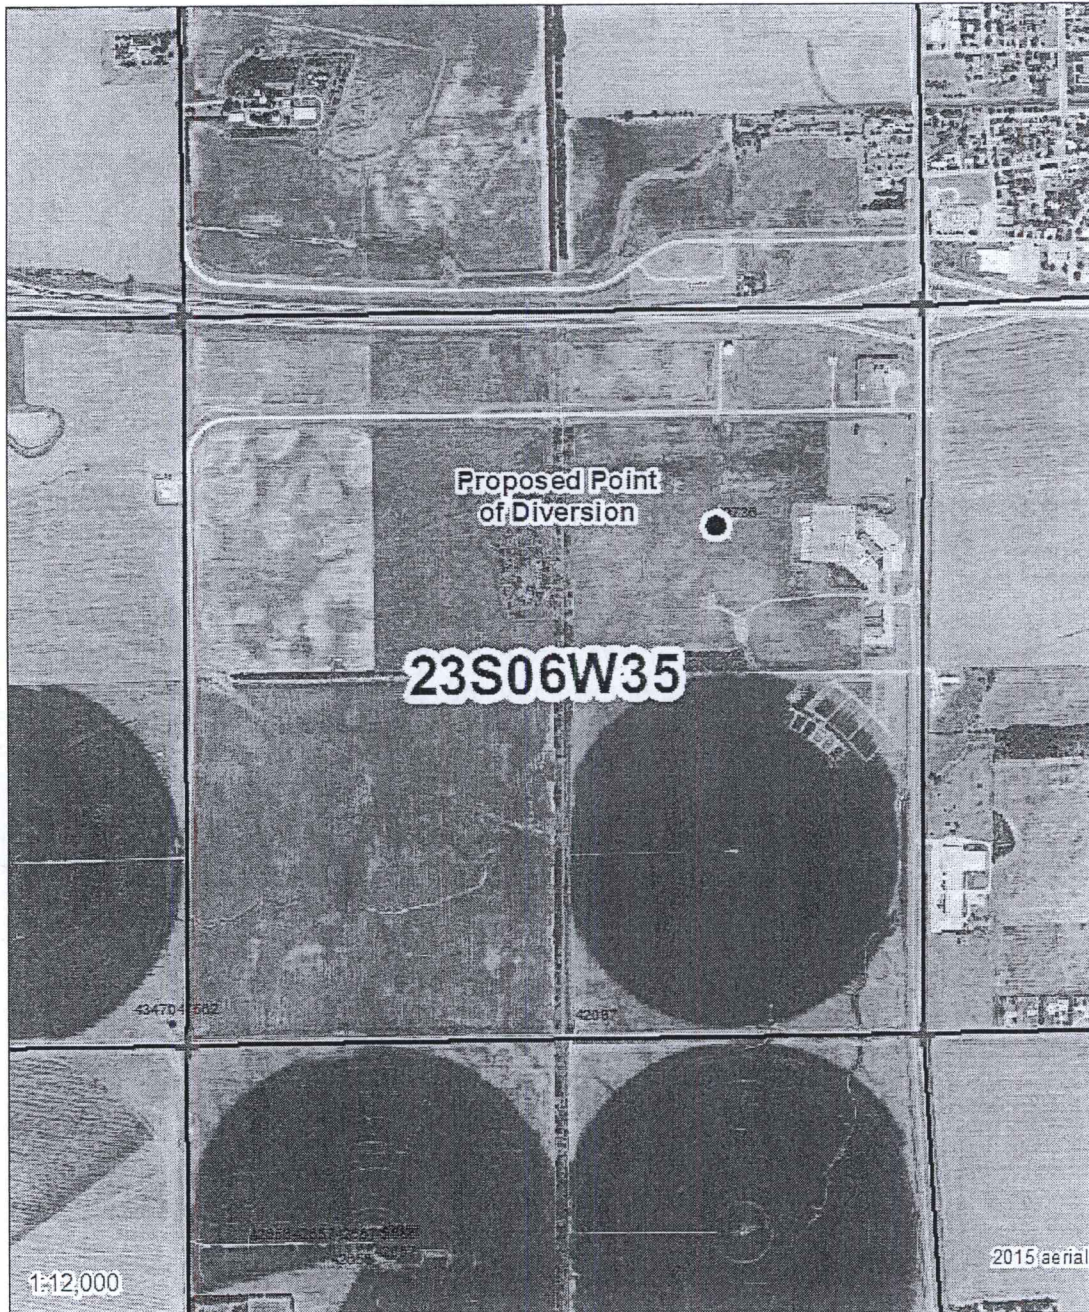
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September 14, 2017

John R & Gloria Evans Revocable Trust
00000 S. K96 Hwy
Hutchinson, KS 67501

Re: Pending Application, File No. 49,736

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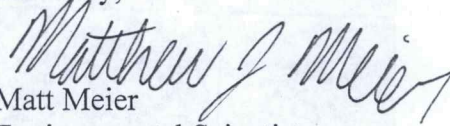
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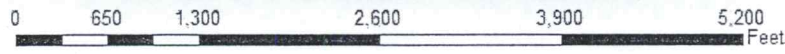
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Three E LLC
2006 S Main St.
South Hutchinson, KS 67505

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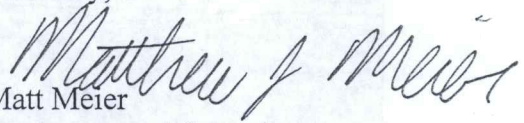
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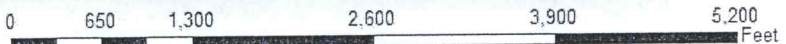
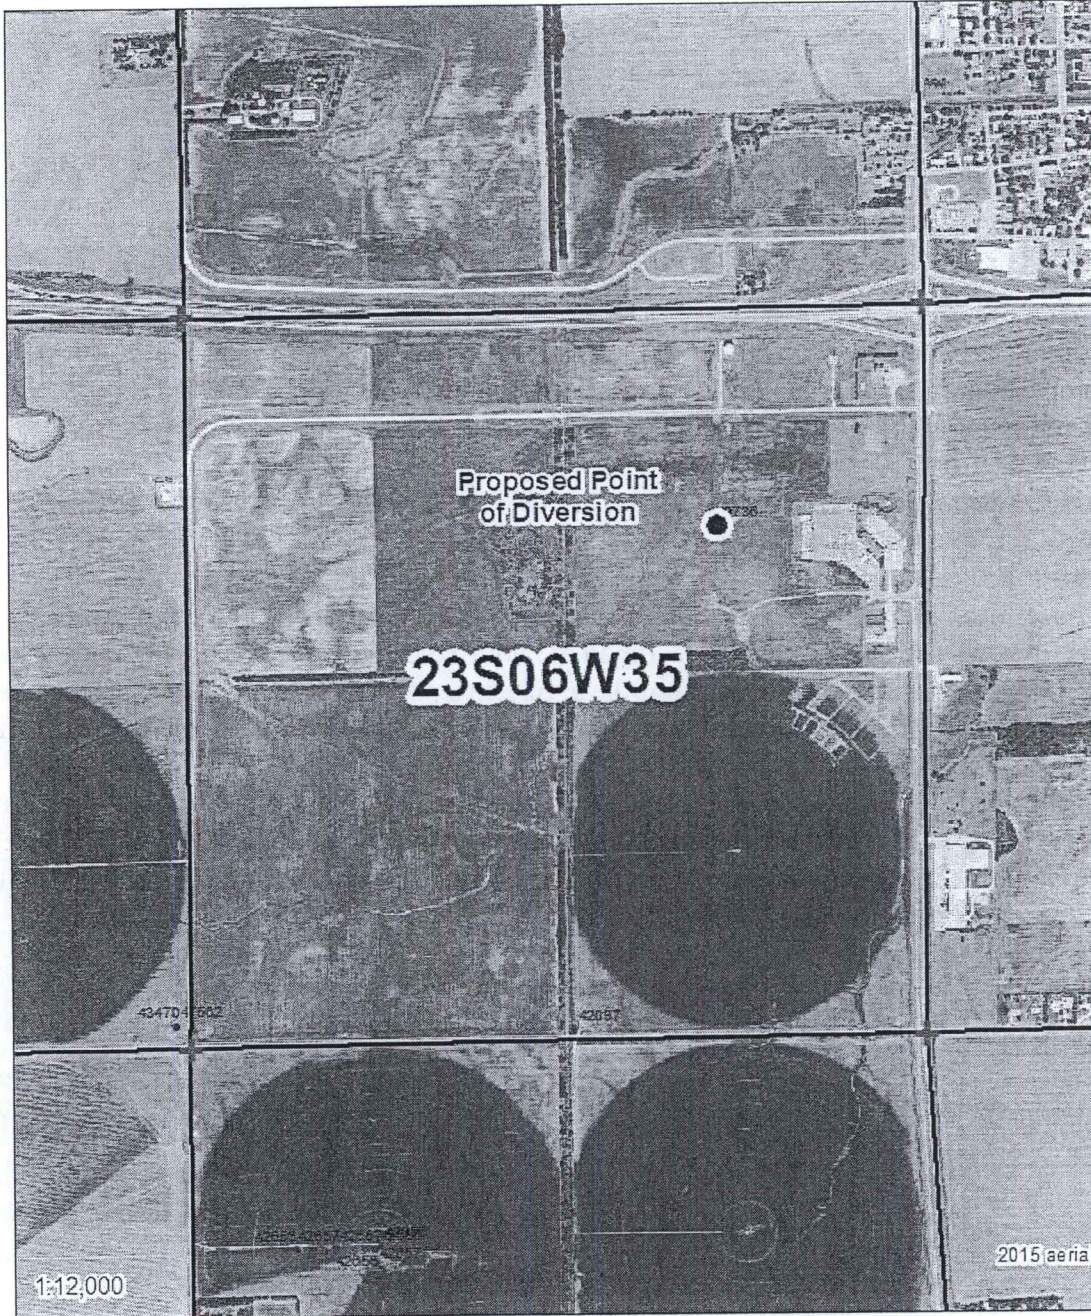
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Sam Brownback, Governor

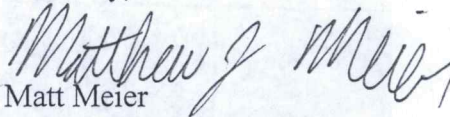September 14, 2017

Breitenback Realty, Inc
00000 S. K96 Hwy
Hutchinson, KS 67501

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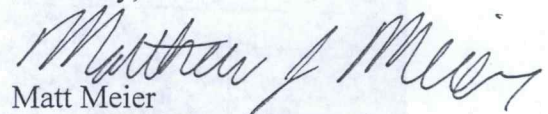
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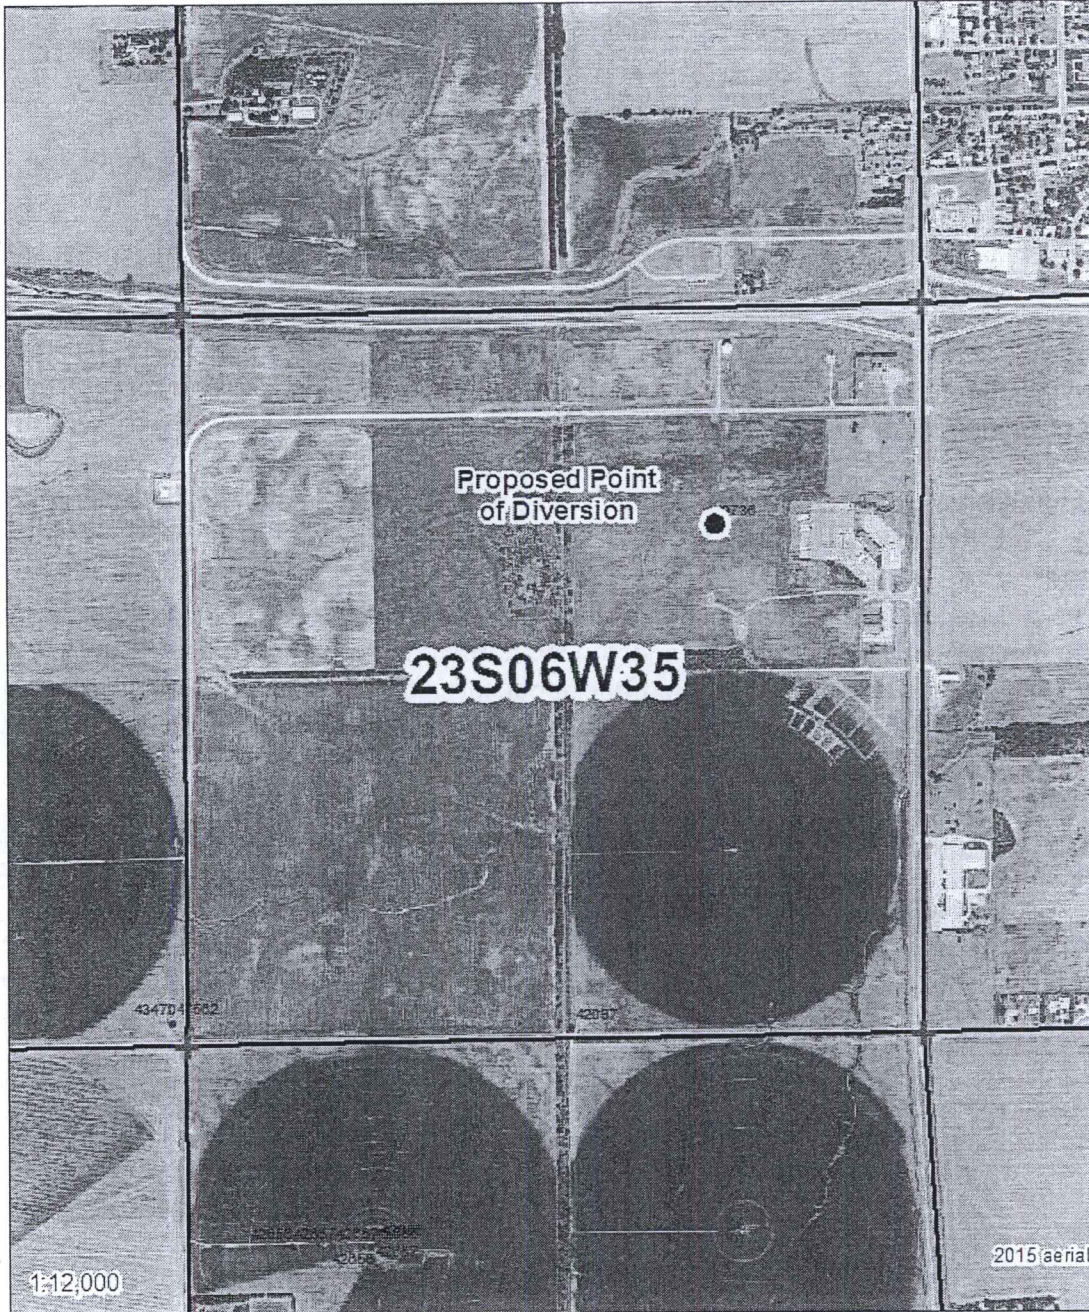
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0 650 1,300 2,600 3,900 5,200 Feet

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MJM-DWR 9/13/17

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Morgan Geneva
00000 S. K96 Hwy
Hutchinson, KS 67501

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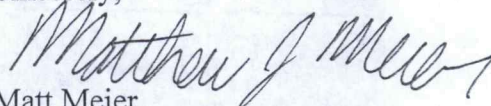
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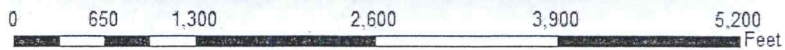
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Reno County



THE STATE OF KANSAS



KANSAS DEPARTMENT OF AGRICULTURE
Jackie McClaskey, Secretary of Agriculture

DIVISION OF WATER RESOURCES
David W. Barfield, Chief Engineer

File Number 49736
This item to be completed by the Division of Water Resources.

WATER RESOURCES RECEIVED

DEC 02 2016

12:30

KS DEPT OF AGRICULTURE

APPLICATION FOR PERMIT TO APPROPRIATE WATER FOR BENEFICIAL USE

Filing Fee Must Accompany the Application
(Please refer to Fee Schedule attached to this application form.)

To the Chief Engineer of the Division of Water Resources, Kansas Department of Agriculture,
1320 Research Park Drive, Manhattan, KS 66502:

1. Name of Applicant (Please Print): Prairie Land Management LLC
Address: 4104 South Herron Road
City: Hutchinson State KS Zip Code 67501
Telephone Number: (620) 727-4291
2. The source of water is: surface water in Unnamed Trib. to Arkansas River
(stream)
OR groundwater in _____
(drainage basin)

Certain streams in Kansas have minimum target flows established by law or may be subject to administration when water is released from storage for use by water assurance district members. If your application is subject to these regulations on the date we receive your application, you will be sent the appropriate form to complete and return to the Division of Water Resources.

3. The maximum quantity of water desired is 40.0 acre-feet OR _____ gallons per calendar year, to be diverted at a maximum rate of 500 NF gallons per minute OR _____ cubic feet per second.
natural flows

Once your application has been assigned a priority, the requested maximum rate of diversion and maximum requested quantity of water under that priority number can **NOT** be increased. Please be certain your requested maximum rate of diversion and maximum quantity of water are appropriate and reasonable for your proposed project and are in agreement with the Division of Water Resources' requirements.

4. The water is intended to be appropriated for (Check use intended):
- (a) Artificial Recharge (b) Irrigation (c) Recreational (d) Water Power
(e) Industrial (f) Municipal (g) Stockwatering (h) Sediment Control
(i) Domestic (j) Dewatering (k) Hydraulic Dredging (l) Fire Protection
(m) Thermal Exchange (n) Contamination Remediation Stormwater Detention

YOU **MUST** COMPLETE AND ATTACH ADDITIONAL DIVISION OF WATER RESOURCES FORM(S) PROVIDING INFORMATION TO SUBSTANTIATE YOUR REQUEST FOR THE AMOUNT OF WATER FOR THE INTENDED USE REFERENCED ABOVE.

For Office Use Only:							
F.O. <u>2</u>	GMD <u>2</u>	Meets K.A.R. 5-3-1 (YES / NO)	Use <u>REC</u>	Source <u>G/S</u>	County <u>RN</u>	By <u>KAB</u>	Date <u>12/2/16</u>
Code <u>REG</u>	Fee \$ <u>200</u>	TR # _____	Receipt Date <u>12/2/16</u>	Check # <u>297</u>			

SCANNED

WATER RESOURCES
RECEIVED

KS DEPT OF AGRICULTURE
JUL 14 1971

411 1314

1971

STATE OF KANSAS

DEPT OF AGRICULTURE

WATER RESOURCES
DIVISION

WATER RESOURCES
DIVISION

WATER RESOURCES
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5. The location of the proposed wells, pump sites or other works for diversion of water is:

Note: For the application to be accepted, the point of diversion location must be described to at least a 10 acre tract, unless you specifically request a 60 day period of time in which to locate the site within a specifically described, minimal legal quarter section of land.

- (A) One in the _____ quarter of the ^{SE SW} quarter of the ^{NE} quarter of Section 35 more particularly described as being near a point 920' feet North and 1500' feet West of the Southeast corner of said section, in Township 23 South, Range 6 East/West (circle one), Reno County, Kansas.
- (B) One in the _____ quarter of the _____ quarter of the _____ quarter of Section _____, more particularly described as being near a point _____ feet North and _____ feet West of the Southeast corner of said section, in Township _____ South, Range _____ East/West (circle one), _____ County, Kansas.
- (C) One in the _____ quarter of the _____ quarter of the _____ quarter of Section _____, more particularly described as being near a point _____ feet North and _____ feet West of the Southeast corner of said section, in Township _____ South, Range _____ East/West (circle one), _____ County, Kansas.
- (D) One in the _____ quarter of the _____ quarter of the _____ quarter of Section _____, more particularly described as being near a point _____ feet North and _____ feet West of the Southeast corner of said section, in Township _____ South, Range _____ East/West (circle one), _____ County, Kansas.

* per phone call w/ Harlan Foraker on 12-2-16

If the source of supply is groundwater, a separate application shall be filed for each proposed well or battery of wells, except that a single application may include up to four wells within a circle with a quarter (1/4) mile radius in the same local source of supply which do not exceed a maximum diversion rate of 20 gallons per minute per well.

A battery of wells is defined as two or more wells connected to a common pump by a manifold; or not more than four wells in the same local source of supply within a 300 foot radius circle which are being operated by pumps not to exceed a total maximum diversion rate of 800 gallons per minute and which supply water to a common distribution system.

6. The owner of the point of diversion, if other than the applicant is (please print):

(name, address and telephone number)

(name, address and telephone number)

You must provide evidence of legal access to, or control of, the point of diversion from the landowner or the landowner's authorized representative. Provide a copy of a recorded deed, lease, easement or other document with this application. In lieu thereof, you may sign the following sworn statement:

I have legal access to, or control of, the point of diversion described in this application from the landowner or the landowner's authorized representative. I declare under penalty of perjury that the foregoing is true and correct.

Executed on _____, 20 16 _____
Applicant's Signature

The applicant must provide the required information or signature irrespective of whether they are the landowner. Failure to complete this portion of the application will cause it to be unacceptable for filing and the application will be returned to the applicant.

7. The proposed project for diversion of water will consist of grassed weir for pond outlet
(number of wells, pumps or dams, etc.)
and (was) will be completed (by) 3-1-17
(Month/Day/Year - each was or will be completed)

8. The first actual application of water for the proposed beneficial use was or is estimated to be 4-1-17
(Mo/Day/Year)

WATER RESOURCES RECEIVED

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DEC 02 2016

UNACCEPTABLE FOR PRIORITY

SCANNED

Handwritten notes in the top left corner, possibly indicating a date or reference number.

Handwritten notes in the top center, including the word "was" and a checkmark.



Handwritten checkmarks and possibly initials or numbers.

WATER RESOURCES RECEIVED

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SCANNED

INACCEPTABLE FOR PRIORITY

REC'D 5/20/04

NEW STREAM WORKSHEET

ES AJW

Date: 12/5/16

File No. 491736

Basin Name: Arkansas Rvr Basin No. 33

Stream Name: Arkansas River Trib 10 A (ANL)

Stream location (confluence with parent stream):

Section 25, Township 23 South, Range 6 ^{West} (East)

Map Color Coding:

Basin Stream – Blue

Named Main Stream off Basin Stream – Yellow

Named Stream off Main Stream – Green

Unnamed Trib (1, 2, 3, 4, etc.) – Pink

Unnamed Trib to Unnamed Trib (A, B, C, etc.) – Orange

Unnamed Trib to Unnamed Trib to Unnamed Trib (1, 2, 3, etc.) – Purple

Stream No. 3892 (computer assigned - entered by data entry staff)

Date Entered 12/6/2016 By UM

NEW STREAM WORKSHEET

ES Adw

Date: 12/5/14

File No. 49,736

Basin Name: Arkansas River Basin No. 33

Stream Name: Arkansas River Trib 10 (Arkansas)

Stream location (confluence with parent stream):

Section 33, Township 23 South, Range 5 ^{West} (East)

Map Color Coding:

Basin Stream – Blue

Named Main Stream off Basin Stream – Yellow

Named Stream off Main Stream – Green

Unnamed Trib (1, 2, 3, 4, etc.) – Pink

Unnamed Trib to Unnamed Trib (A, B, C, etc.) – Orange

Unnamed Trib to Unnamed Trib to Unnamed Trib (1, 2, 3, etc.) – Purple

Stream No. 3091 (computer assigned - entered by data entry staff)

Date Entered 12/6/2016 By LCM

- 9. Will pesticide, fertilizer, or other foreign substance be injected into the water pumped from the diversion works?
 Yes No If "yes", a check valve shall be required.

All chemigation safety requirements must be met including a chemigation permit and reporting requirements.

- 10. If you are planning to impound water, please contact the Division of Water Resources for assistance, prior to submitting the application. Please attach a reservoir area capacity table and inform us of the total acres of surface drainage area above the reservoir.

Have you also made an application for a permit for construction of this dam and reservoir with the Division of Water Resources? Yes No

- If yes, show the Water Structures permit number here _____
- If no, explain here why a Water Structures permit is not required No dam is being constructed.
A pit pond is being proposed. Also DWR permit is not required as drainage basin is
less than 1 sq. mile and structure is non-jurisdictional.

- 11. The application must be supplemented by a U.S.G.S. topographic map, aerial photograph or a detailed plat showing the following information. On the topographic map, aerial photograph, or plat, identify the center of the section, the section lines or the section corners and show the appropriate section, township and range numbers. Also, please show the following information:

- (a) The location of the proposed point(s) of diversion (wells, stream-bank installations, dams, or other diversion works) should be plotted as described in Paragraph No. 5 of the application, showing the North-South distance and the East-West distance from a section line or southeast corner of section.
- (b) If the application is for groundwater, please show the location of any existing water wells of any kind within 1/2 mile of the proposed well or wells. Identify each existing well as to its use and furnish the name and mailing address of the property owner or owners. If there are no wells within 1/2 mile, please advise us.
- (c) If the application is for surface water, the names and addresses of the landowner(s) 1/2 mile downstream and 1/2 mile upstream from your property lines must be shown.
- (d) The location of the proposed place of use should be shown by crosshatching on the topographic map, aerial photograph or plat.
- (e) Show the location of the pipelines, canals, reservoirs or other facilities for conveying water from the point of diversion to the place of use.

A 7.5 minute U.S.G.S. topographic map may be obtained by providing the section, township and range numbers to: Kansas Geological Survey, 1930 Constant, Campus West, University of Kansas, Lawrence, Kansas 66047.

- 12. List any application, appropriation of water, water right, or vested right file number that covers the same diversion points or any of the same place of use described in this application. Also list any other recent modifications made to existing permits or water rights in conjunction with the filing of this application.

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1. The first part of the document discusses the importance of water resources in the state of Kansas. It highlights the challenges faced by the state, such as drought and population growth, and the need for sustainable water management practices.

2. The second part of the document focuses on the role of agriculture in the state's economy and the impact of water scarcity on farming. It discusses various agricultural practices and the need for irrigation systems to ensure crop production during dry periods.

3. The third part of the document addresses the issue of water quality and the impact of agricultural runoff on the environment. It discusses the need for conservation practices and the implementation of water quality standards to protect the state's water resources.

4. The fourth part of the document discusses the role of government in water resource management. It highlights the need for regulatory agencies and the implementation of water conservation programs to ensure the sustainable use of water resources.

5. The fifth part of the document discusses the role of the private sector in water resource management. It highlights the need for investment in water infrastructure and the implementation of water conservation programs to ensure the sustainable use of water resources.

6. The sixth part of the document discusses the role of the public in water resource management. It highlights the need for public participation in water conservation programs and the implementation of water conservation programs to ensure the sustainable use of water resources.

7. The seventh part of the document discusses the role of education in water resource management. It highlights the need for water conservation education programs and the implementation of water conservation programs to ensure the sustainable use of water resources.

8. The eighth part of the document discusses the role of research in water resource management. It highlights the need for water conservation research programs and the implementation of water conservation programs to ensure the sustainable use of water resources.

9. The ninth part of the document discusses the role of policy in water resource management. It highlights the need for water conservation policies and the implementation of water conservation programs to ensure the sustainable use of water resources.

10. The tenth part of the document discusses the role of technology in water resource management. It highlights the need for water conservation technology programs and the implementation of water conservation programs to ensure the sustainable use of water resources.

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13. Furnish the following well information if the proposed appropriation is for the use of groundwater. If the well has not been completed, give information obtained from test holes, if available.

Information below is from: Test holes Well as completed Drillers log attached

Well location as shown in paragraph No.	(A)	(B)	(C)	(D)
Date Drilled	_____	_____	_____	_____
Total depth of well	_____	_____	_____	_____
Depth to water bearing formation	_____	_____	_____	_____
Depth to static water level	_____	_____	_____	_____
Depth to bottom of pump intake pipe	_____	_____	_____	_____

14. The relationship of the applicant to the proposed place where the water will be used is that of Owner
(owner, tenant, agent or otherwise)

15. The owner(s) of the property where the water is used, if other than the applicant, is (please print):

(name, address and telephone number)

(name, address and telephone number)

16. The undersigned states that the information set forth above is true to the best of his/her knowledge and that this application is submitted in good faith.

Dated at Hutchinson, Kansas, this _____ day of November, 2016.
(month) (year)

Richard Graber
(Applicant Signature)

By _____
(Agent or Officer Signature)

Richard Graber
(Agent or Officer - Please Print)

Assisted by _____ Date: _____
(office/title)

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(Date)

Kansas Department of Agriculture
Division of Water Resources
David W. Barfield, Chief Engineer
109 SW 9th Street, 2nd Floor
Topeka, Kansas 66612-1283

Re: Application
File No. _____

Minimum Desirable Streamflow

Dear Sir:

I understand that a Minimum Desirable Streamflow requirement has been established by the legislature for the source of supply to which the above referenced application applies.

I understand that diversion of water pursuant to this application will be subject to regulation any time Minimum Desirable Streamflow requirements are not being met.

I also understand that if this application is approved, there could be times, as determined by the Division of Water Resources, when I would not be allowed to divert water. I realize that this could affect the economics of my decision to appropriate water.

I am aware of the above factors, and with the knowledge thereof, request that the Division of Water Resources proceed with processing and approval, if possible, of the above referenced application.




Signature of Applicant

State of Kansas)
County of Reno) ss
_____)

Richard Graber. Prairie Land
(Print Applicant's Name)

I hereby certify that the foregoing instrument was signed in my presence and sworn to before me this 16 day of November, 20 16.

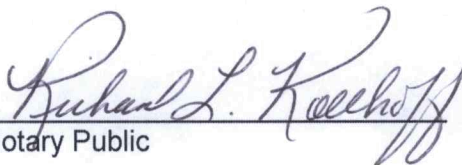

Notary Public

My Commission Expires: 2-22-19

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DWR **KS DEPT. OF AGRICULTURE**
(Revised 03/27/2008)


RICHARD L. KOLLHOFF
Notary Public - State of Kansas
My Appt. Expires 2-22-19

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1. The first part of the report is a general introduction to the subject of the study. It discusses the importance of the subject and the objectives of the study.

2. The second part of the report is a detailed description of the methodology used in the study. It includes a description of the data sources, the data collection methods, and the data analysis methods.

3. The third part of the report is a discussion of the results of the study. It includes a description of the findings and a discussion of the implications of the findings.

4. The fourth part of the report is a conclusion and a list of references. The conclusion summarizes the main findings of the study and provides recommendations for further research.

5. The fifth part of the report is an appendix containing additional information related to the study, such as raw data, detailed calculations, and additional figures.

[Handwritten signature]
Name of the author

Position of the author
Institution

[Handwritten signature]
Name of the author

Position of the author
Institution

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**RECREATIONAL USE
SUPPLEMENTAL SHEET**

File No. _____

Name of Applicant (Please Print): Richard Graber, Prairie Land Construction

1. Please indicate type of recreational use (boating, fishing, swimming, etc.): _____
Pond is required to provide detention storage and water quality for Commercial
development. Pond will be used for RV park fishing and swimming.

2. Please summarize how the water will be used and justify the quantity of water requested: _____
Pond will be used for RV park recreation including fishing and swimming.
Proposed pond surface area is 192,492 sq.ft. = 4.42 acres.
Annual Evaporation = 4.42 acres x 26"/12=9.58 acre-feet.

3. Please complete the following table showing estimated future water requirements:

ESTIMATED FUTURE WATER DIVERTED/STORED	
NEXT 5 YEARS	WATER TO BE DIVERTED (ACRE-FEET OR GALLONS)
Year 1	28.73 acre-feet(Pond Filling)
Year 2	28.73 acre-feet(Annual evaporation and seepage)
Year 3	28.73 acre-feet(Annual evaporation and seepage)
Year 4	28.73 acre-feet(Annual evaporation and seepage)
Year 5	28.73 acre-feet(Annual evaporation and seepage)

Please attach any additional information, tables, or curves showing past, present and estimated future water requirements to substantiate the amount of water requested.

4. Please designate the legal description of the location where the water is to be used by providing the fractional part of the Section, Township and Range.

SW 1/4, NE 1/4, Sec. 35, T.23S., R.6W., Reno County, KS

You may attach any additional information you believe will assist in informing the Division of the need for your request.

STATE OF CALIFORNIA
DEPARTMENT OF WATER RESOURCES

Water Right No. 123456
Diversion Point: [illegible]

Water Right Holder: [illegible]
Beneficial Use: [illegible]

Priority Date: [illegible]
Point of Diversion: [illegible]

Quantity: [illegible]
Type of Right: [illegible]

Location: [illegible]
County: [illegible]

Remarks: [illegible]

Recorded in Book [illegible] Page [illegible]

Filed for Record on [illegible]

By [illegible]

Witness: [illegible]

Notary Public: [illegible]

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12/15/2010

12/15/2010

Frontier Commerce Park



Tue Nov 22 2016 12:26:37 PM.

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1320 Research Park Drive
Manhattan, Kansas 66502

Jackie McClaskey, Secretary



Phone: (785) 564-6700

Fax: (785) 564-6777

Email: ksag@kda.ks.gov

www.agriculture.ks.gov

Sam Brownback, Governor

December 5, 2016

PRAIRIE LAND MANAGEMENT LLC
4104 S HERRON RD
HUTCHINSON KS 67501

FILE COPY

RE: Application
File No. 49736

Dear Sir or Madam:

Your application for permit to appropriate water in 35-23S-6W in Reno County, was received and has been assigned the file number noted above.

As a matter of record, the Division of Water Resources has on hand a large number of applications awaiting processing. Therefore to be fair to all concerned, and so that we can process those applications on hand in the order they were received, we intend to concentrate on the backlog of applications until the issue is resolved. Once review of your application has begun, we will contact you, if additional information is required.

In accordance with the provisions of the Kansas Water Appropriation Act, a portion of which is included below, the use of water as proposed prior to approval of the application is unlawful. Once approved, compliance with the terms, conditions and limitations of the permit is necessary. Conservation of the water resources of Kansas is required.

Section 82a-728 of the Kansas Water Appropriation Act, provides (a) except for the appropriation of water for the purpose of domestic use, . . . it shall be unlawful for any person to appropriate or threaten to appropriate water from any source without first applying for and obtaining a permit to appropriate water in accordance with the provisions of the Water Appropriation Act or for any person to violate any condition of a vested right, appropriation right or an approved application for a permit to appropriate water for beneficial use.

(b) (1) The violation of any provision of this section by any person is a class C misdemeanor . . .

A class C misdemeanor is punishable by a fine not to exceed \$500 and/or a term of confinement not to exceed one month in the county jail. Each day that the violation occurs constitutes a separate offense.


If you have any questions, please contact me at (785) 564-6645. If you wish to discuss a specific file, please have the file number ready so that we may help you more efficiently.

Sincerely,

Brent A Turney, P.G.
Change Application Unit Supervisor
Water Appropriation Program

BAT: dlw
pc: STAFFORD Field Office
GMD

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GENERAL NOTES

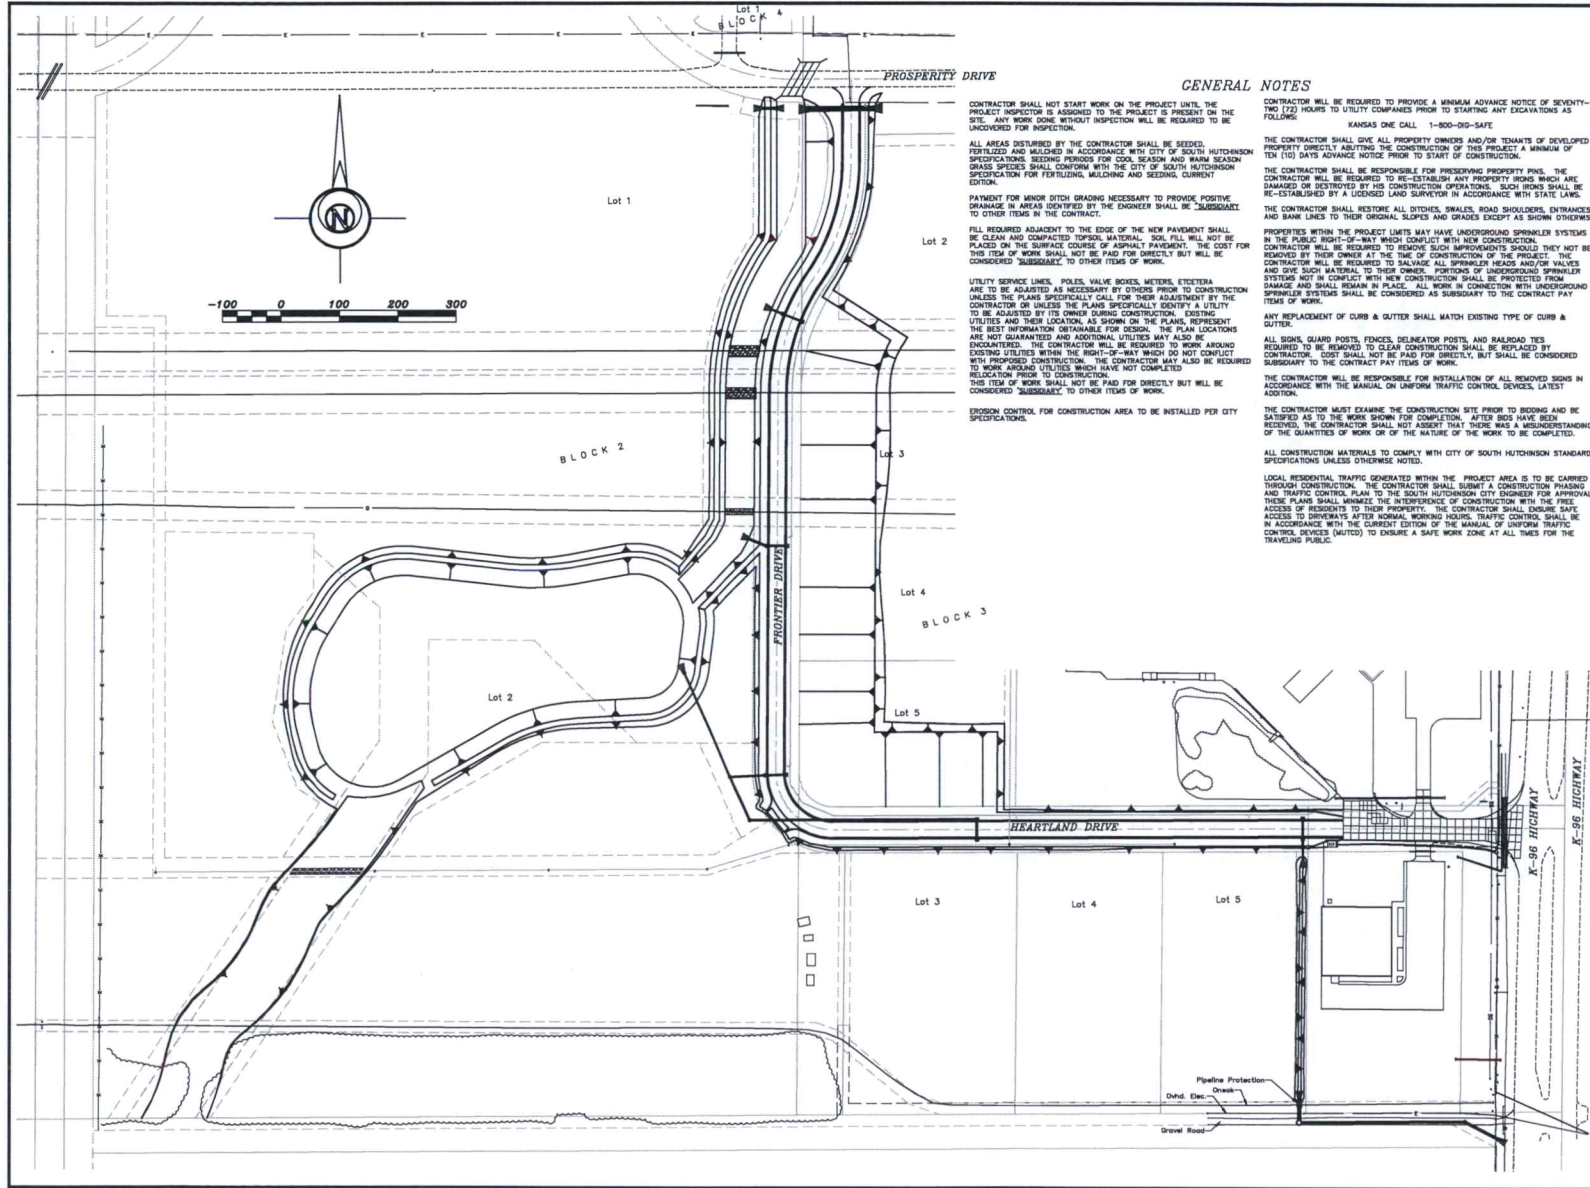CONTRACTOR SHALL NOT START WORK ON THE PROJECT UNTIL THE PROJECT INSPECTOR IS ASSIGNED TO THE PROJECT IS PRESENT ON THE SITE. ANY WORK DONE WITHOUT INSPECTION WILL BE REQUIRED TO BE UNDOING FOR INSPECTION.

ALL AREAS DISTURBED BY THE CONTRACTOR SHALL BE SEEDED, FERTILIZED AND MULCHED IN ACCORDANCE WITH CITY OF SOUTH HUTCHINSON SPECIFICATIONS. SEEDING PERIODS FOR COOL SEASON AND WARM SEASON GRASS SPECIES SHALL CONFORM WITH THE CITY OF SOUTH HUTCHINSON SPECIFICATION FOR FERTILIZING, MULCHING AND SEEDING, CURRENT EDITION.

PAYMENT FOR MINOR DITCH GRADING NECESSARY TO PROVIDE POSITIVE DRAINAGE IN AREAS IDENTIFIED BY THE OWNER SHALL BE "SUBSIDIARY" TO OTHER ITEMS IN THE CONTRACT.

FILL REQUIRED ADJACENT TO THE EDGE OF THE NEW PAVEMENT SHALL BE CLEAN AND COMPACTED TOPSOIL MATERIAL. SOIL FILL WILL NOT BE PLACED ON THE SURFACE COURSE OF ASPHALT PAVEMENT. THE COST FOR THIS ITEM OF WORK SHALL NOT BE PAID FOR DIRECTLY BUT WILL BE CONSIDERED "SUBSIDIARY" TO OTHER ITEMS OF WORK.

UTILITY SERVICE LINES, POLES, VALVE BOXES, METERS, ETCETERA ARE TO BE ADJUSTED AS NECESSARY BY OTHERS PRIOR TO CONSTRUCTION UNLESS THE PLANS SPECIFICALLY CALL FOR THEIR ADJUSTMENT BY THE CONTRACTOR OR UNLESS THE PLANS SPECIFICALLY IDENTIFY A UTILITY TO BE ADJUSTED BY ITS OWNER DURING CONSTRUCTION. EXISTING UTILITIES AND THEIR LOCATIONS AS SHOWN ON THE PLANS REPRESENT THE BEST INFORMATION OBTAINABLE FOR DESIGN. THE PLAN LOCATIONS ARE NOT GUARANTEED AND ADDITIONAL UTILITIES MAY ALSO BE ENCOUNTERED. THE CONTRACTOR WILL BE REQUIRED TO WORK AROUND EXISTING UTILITIES WITHIN THE RIGHT-OF-WAY WHICH DO NOT CONFLICT WITH PROPOSED CONSTRUCTION. THE CONTRACTOR MAY ALSO BE REQUIRED TO WORK AROUND UTILITIES WHICH HAVE NOT COMPLETED.

THIS ITEM OF WORK SHALL NOT BE PAID FOR DIRECTLY BUT WILL BE CONSIDERED "SUBSIDIARY" TO OTHER ITEMS OF WORK.

EROSION CONTROL FOR CONSTRUCTION AREA TO BE INSTALLED PER CITY SPECIFICATIONS.

CONTRACTOR SHALL BE REQUIRED TO PROVIDE A MINIMUM ADVANCE NOTICE OF SEVENTY-TWO (72) HOURS TO UTILITY COMPANIES PRIOR TO STARTING ANY EXCAVATIONS AS FOLLOWS: KANSAS ONE CALL 1-800-292-SAFE.

THE CONTRACTOR SHALL GIVE ALL PROPERTY OWNERS AND/OR TENANTS OF DEVELOPED PROPERTY DIRECTLY ADJUTING THE CONSTRUCTION OF THIS PROJECT A MINIMUM OF TEN (10) DAYS ADVANCE NOTICE PRIOR TO START OF CONSTRUCTION.

THE CONTRACTOR SHALL BE RESPONSIBLE FOR PRESERVING PROPERTY PINS. THE CONTRACTOR WILL BE REQUIRED TO RE-ESTABLISH ANY PROPERTY BOUNDS WHICH ARE DAMAGED OR DESTROYED BY HIS CONSTRUCTION OPERATIONS. SUCH BOUNDS SHALL BE RE-ESTABLISHED BY A LICENSED LAND SURVEYOR IN ACCORDANCE WITH STATE LAWS.

THE CONTRACTOR SHALL RESTORE ALL DITCHES, SHOULDER, ROAD SHOULDER, ENTRANCES AND BANK LINES TO THEIR ORIGINAL SLOPES AND GRADES EXCEPT AS SHOWN OTHERWISE.

PROPERTIES WITHIN THE PROJECT LIMITS MAY HAVE UNDERGROUND SPRINKLER SYSTEMS IN THE PUBLIC RIGHT-OF-WAY WHICH CONFLICT WITH NEW CONSTRUCTION. CONTRACTOR WILL BE REQUIRED TO REMOVE SUCH IMPROVEMENTS SHOULD THEY NOT BE REQUIRED BY THEIR OWNER AT THE TIME OF CONSTRUCTION OF THE PROJECT. THE CONTRACTOR WILL BE REQUIRED TO SALVAGE ALL SPRINKLER HEADS AND/OR VALVES AND GIVE SUCH MATERIAL TO THEIR OWNER. PORTIONS OF UNDERGROUND SPRINKLER SYSTEMS NOT IN CONFLICT WITH NEW CONSTRUCTION SHALL BE PROTECTED FROM DAMAGE AND SHALL REMAIN IN PLACE. ALL WORK IN CONNECTION WITH UNDERGROUND SPRINKLER SYSTEMS SHALL BE CONSIDERED AS SUBSIDIARY TO THE CONTRACT PAY ITEMS OF WORK.

ANY REPLACEMENT OF CURB & GUTTER SHALL MATCH EXISTING TYPE OF CURB & GUTTER.


ALL SIGNS, GUARD POSTS, FENCES, DELIMITER POSTS, AND ROADWAY TIES REQUIRED TO BE REMOVED TO CLEAN CONSTRUCTION SHALL BE REPLACED BY CONTRACTOR. COST SHALL NOT BE PAID FOR DIRECTLY, BUT SHALL BE CONSIDERED SUBSIDIARY TO THE CONTRACT PAY ITEMS OF WORK.

THE CONTRACTOR WILL BE RESPONSIBLE FOR INSTALLATION OF ALL REMOVED SIGNS IN ACCORDANCE WITH THE MANUAL ON UNIFORM TRAFFIC CONTROL DEVICES, LATEST EDITION.

THE CONTRACTOR MUST EXAMINE THE CONSTRUCTION SITE PRIOR TO BIDDING AND BE SATISFIED AS TO THE WORK SHOWN FOR COMPLETION. AFTER BIDS HAVE BEEN RECEIVED, THE CONTRACTOR SHALL NOT ASSERT THAT THERE WAS A MISUNDERSTANDING OF THE QUANTITIES OF WORK OR OF THE NATURE OF THE WORK TO BE COMPLETED.

ALL CONSTRUCTION MATERIALS TO COMPLY WITH CITY OF SOUTH HUTCHINSON STANDARD SPECIFICATIONS UNLESS OTHERWISE NOTED.

LOCAL RESIDENTIAL TRAFFIC GENERATED WITHIN THE PROJECT AREA IS TO BE CARRIED THROUGH CONSTRUCTION. THE CONTRACTOR SHALL SUBMIT A CONSTRUCTION PHASING AND TRAFFIC CONTROL PLAN TO THE SOUTH HUTCHINSON CITY ENGINEER FOR APPROVAL. THESE PLANS SHALL MINIMIZE THE INTERFERENCE OF CONSTRUCTION WITH THE FREE ACCESS OF RESIDENTS TO THEIR PROPERTY. THE CONTRACTOR SHALL ENSURE SAFE ACCESS TO DRIVEWAYS AFTER NORMAL WORKING HOURS. TRAFFIC CONTROL SHALL BE IN ACCORDANCE WITH THE CURRENT EDITION OF THE MANUAL OF UNIFORM TRAFFIC CONTROL DEVICES (MUTCD) TO ENSURE A SAFE WORK ZONE AT ALL TIMES FOR THE TRAVELING PUBLIC.

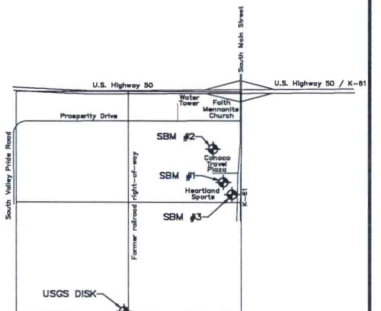

VERTICAL AND HORIZONTAL PROJECT CONTROL:

N=1798070.7750 E=1470973.5000
 USGS Azimuth Mark disk set in concrete post stamped "Oak Az Mk" located 27 feet North of the centerline of West Morgan Avenue approximately 1/2 mile West of K-61 and 50 feet West of the former AT&SF railroad (now wooded & razed). Elevation=1546.72 (NAVD88)


SBM #1 N=1801078.7487 E=1473213.7078
 Square cut on the Southwest corner of a concrete pad for an electric box that is 163ft West of the entrance to Heartland Outdoor Store. Elevation=1538.65 (NAVD88)

SBM #2 N=1801844.4099 E=1472978.1589
 Blue capped rebar in concrete 167ft West and 84ft North of the Northeast corner of the Cornco Pizzeria truck parking lot. Elevation=1540.26 (NAVD88)

SBM #3 N=1800795.5778 E=1473408.4049
 Blue square cut in the South edge of the concrete and 205 feet East of the Southwest corner of the Heartland Outdoor concrete parking lot. Elevation=1537.11 (NAVD88)

FRONTIER COMMERCE PARK LAYOUT SHEET STREET IMPROVEMENTS SOUTH HUTCHINSON, KANSAS CERTIFIED ENGINEERING DESIGN, P.A.		
1935 WEST MAPLE WICHITA, KANSAS 67213 PH.(316)262-8808 FAX.(316)262-1669		
DESIGNED: HOF	SCALE: 1"=100'	SHEET: 2
DRAWN: N/A	DATE: 07/25/2018	
CHECKED: HOF	CED FILE: 088 02014-767	TOTAL: 47

SCANNED

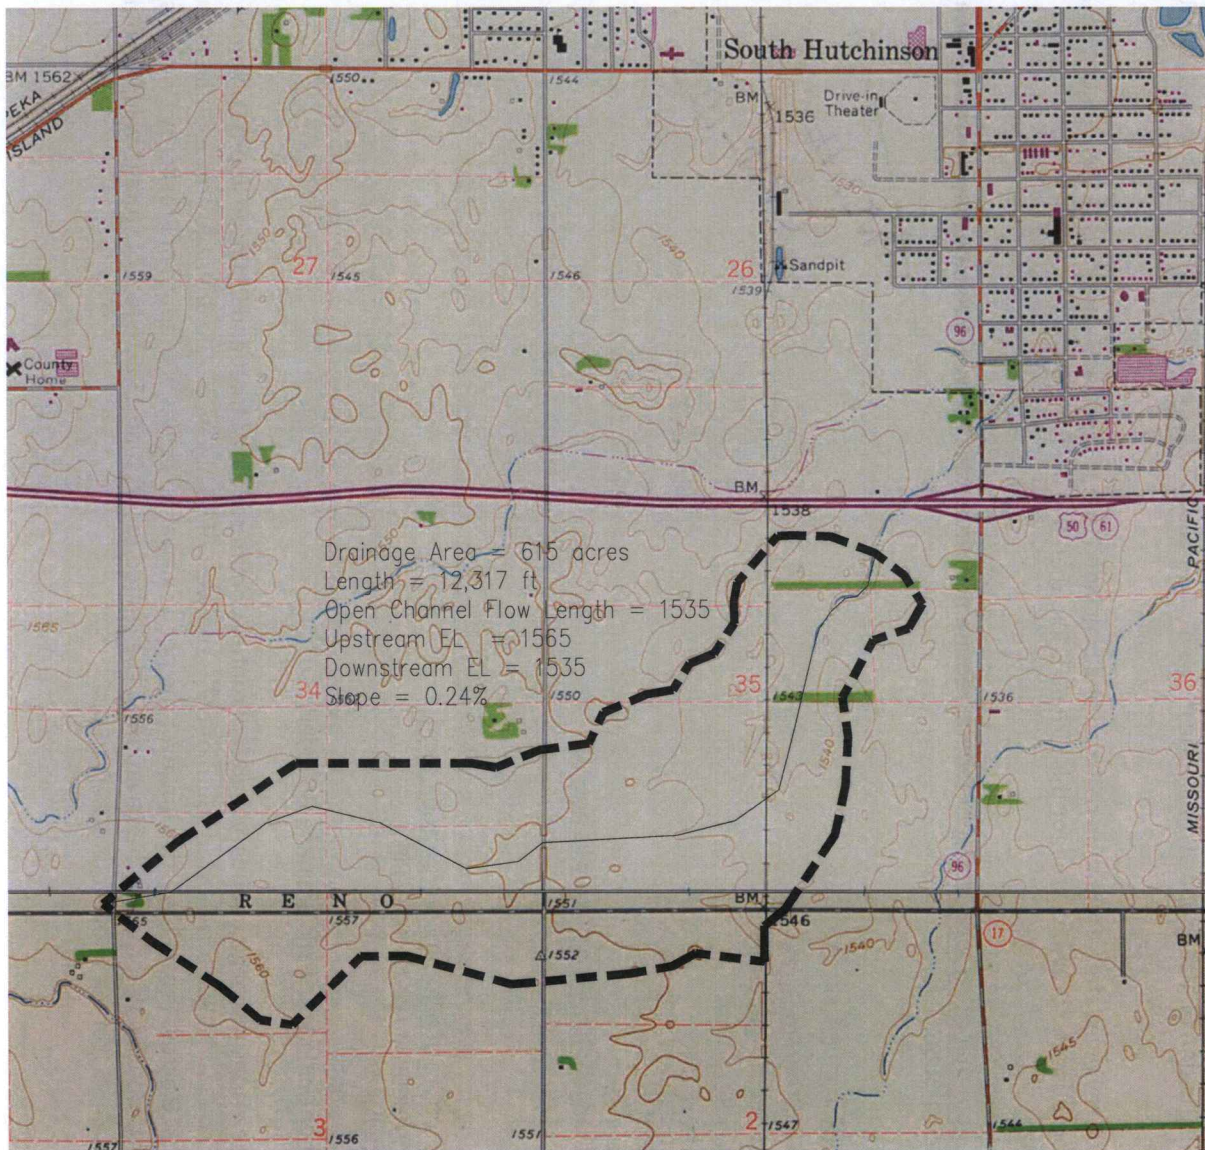

Phillips, Janelle

From: Phillips, Janelle
Sent: Wednesday, August 24, 2016 8:11 AM
To: 'Harlan Foraker'
Subject: RE: Frontier Commerce Park Drainage Boundary

This will acknowledge receipt of your request for a water structures permit determination. The project will consist of the construction of a pit pond at a location in the NE ¼ of Section 35, Township 23 South, Range 6 West, Reno County, Kansas.

We have reviewed the information received and concluded that this project is not jurisdictional under K.S.A. 82a-301 to 305a, because the drainage area for this stream is less than 640 acres. A DWR permit will not be required for this project.

Please note that other local, state, or federal requirements may still apply. If you have any questions, please contact me at 785-564-6656.

Janelle N. Phillips, P.E., C.F.M., LEED-AP
Water Structures Program
Kansas Department of Agriculture
Division of Water Resources
1320 Research Park Drive
Manhattan, KS 66502
785-564-6656

My email has changed: janelle.phillips@ks.gov

WSI-#
CRN-120

From: Harlan Foraker [<mailto:hforaker@cedpa.com>]
Sent: Tuesday, August 23, 2016 6:01 PM
To: Phillips, Janelle
Cc: lmills@cedpa.com
Subject: Frontier Commerce Park Drainage Boundary

Janelle: Attached is the drainage boundary map for Frontier Commerce Park Street and Drainage Improvement project in South Hutchinson, Reno County, KS. It is located south of US50 and west of 96 highway. The drainage area is outlined and measured to and existing RCB across Prosperity Drive however the pond excavation begins 900' south of Prosperity Drive. As site plan is attached. I am proposing that the pond excavation will be limited to less than 15 acre feet of storage volume until the water right can be obtained. Let me know your observations.



Harlan D. Foraker, P.E., President
Certified Engineering Design, P.A.
1935 West Maple
Wichita, KS 67213-3311
PH:(316)262-8808
FAX:(316)262-1669

Barry Kistner

From:
Sent:
To:
Subject:

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Kristen A. Baum
Division of Water Resources - Water A
Kansas Department of Agriculture
1550 Research Park Dr
Manhattan KS 66505
(785) 281-6677

From: Barry Kistner
Sent: Friday, December 07, 2018 10:25 AM
To: Kristen Baum
Subject: RE: Pioneer Commerce Park, Le Roy, KS

Kristen, attached is the contract we signed with Pioneer Commerce Park, Le Roy, KS. The contract is for the purchase of the land and the construction of a water treatment facility. The contract is for the purchase of the land and the construction of a water treatment facility. The contract is for the purchase of the land and the construction of a water treatment facility.

Baum, Kristen

From: Harlan Foraker <hforaker@cedpa.com>
Sent: Friday, December 02, 2016 11:45 AM
To: Baum, Kristen
Subject: RE: Frontier Commerce Park Water Rights application

Yes natural flows is acceptable as I did not know what value to put for this. Also can you advise what the typical timeline is for review and consideration for approval of these water permits? I just need to advise Richard Graber what to expect. Thanks.

Harlan D. Foraker, P.E., President
Certified Engineering Design, P.A.
1935 West Maple
Wichita, KS 67213-3311
PH:(316)262-8808
FAX:(316)262-1669

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From: Baum, Kristen [<mailto:Kristen.Baum@ks.gov>]
Sent: Friday, December 02, 2016 11:35 AM
To: Harlan Foraker
Subject: RE: Frontier Commerce Park Water Rights application

Thanks for the additional information. One more thing I'd like to clarify – the rate of diversion you've requested is 500 gpm. This will be in the form of natural flows, correct? If so, we would describe the rate as "natural flows" rather than a specific gpm.

Thanks,

Kristen A. Baum
Division of Water Resources – Water Appropriations
Kansas Department of Agriculture
1320 Research Park Drive
Manhattan KS 66502
(785) 564-6627

My email address has changed: kristen.baum@ks.gov

From: Harlan Foraker [<mailto:hforaker@cedpa.com>]
Sent: Friday, December 02, 2016 11:16 AM
To: Baum, Kristen
Subject: Frontier Commerce Park Water Rights application

Kristen: Attached are the updated documents as we discussed. I checked the pond surface area at the spillway elevation and the surface area is actually 4.42 acres. Also attached is Sheet 50 which contains the final plat for Frontier Commerce Park Addition from the street improvement plans which contains the Owner's Certificate and the signature for Prairie Land Management LLC owned by Richard Graber. Please review and let me know if you have any questions or require additional information.



Harlan D. Foraker, P.E., President
Certified Engineering Design, P.A.
1935 West Maple
Wichita, KS 67213-3311

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*per phone call,
3 yrs evap
w/ some initial
fill

A.
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e
x

KAB
12-2-16

LETTER OF TR

DATE: November 22, 2016

TO: Chief Engineer
Division of Water Resources
Kansas Department of Agriculture
1320 Research Park Drive
Manhattan, Kansas 66502

KS DEPT OF AGRICULTURE

Re: Surface Water Rights Application
South Hutchinson, Reno County, KS

FROM: Harlan D. Foraker, P.E. *HDF*

COMMENTS: Attached is a surface water rights application for 30 ac-ft for a recreational pond at the Frontier Commerce Park Addition in South Hutchinson, Reno County, Kansas. A \$200 application fee is attached. Please review the application, maps and plans for the proposed permit and ponds and notify us if any further information is required. If you have questions or require additional information please call me at 316.262.8808.

attachments

cc by email: Mr. Richard Graber, Prairie Land Management, 4104 S. Herron Road, Hutchinson, KS, 66501

WATER RESOURCES
RECEIVED

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SCANNED

1) North

0781273501001002000
Faith Mennonite Church
1403 S. Main St.
South Hutchinson, KS 67505
11.64 acres

2) Gas Station

0781273501001005000
CTP LLC
1515 S. Main St.
South Hutchinson, KS 67505
19.84 acres

3) East of 96

0781273602001002000
Dokocil, Larry D. Liv Trust
00000 S. K96 HWY
Hutchinson, KS 67501
67.77 acres

4) South of Frontier Commerce Park

0781273500002002000
Evans, John R & Gloria A Revocable Trust
00000 S. K96 HWY
Hutchinson, KS 67501
135.47 acres

5) Southeast

0781273600002003000
Three E LLC
2006 S. Main St.
South Hutchinson, KS 67505
4.52 Acres

6) Southeast

0781273600002004000
Breitenback Realty, Inc.
00000 S. K96 HWY
Hutchinson, KS 67501
7.48 acres

7) Southeast

0781273600002002000
Morgan, Geneva E
00000 S. K96 HWY
Hutchinson, KS 67501
43.68 acres

WATER RESOURCES
RECEIVED

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WATER RESOURCES
RECEIVED

UNACCEPTABLE FOR PRIORITY
DEC 01 2016

KS DEPT OF AGRICULTURE


SCANNED

WATER RESOURCES
RECEIVED

KS DEPT OF AGRICULTURE

WATER RESOURCES
RECEIVED

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Project Location
DA = 574.93 acres

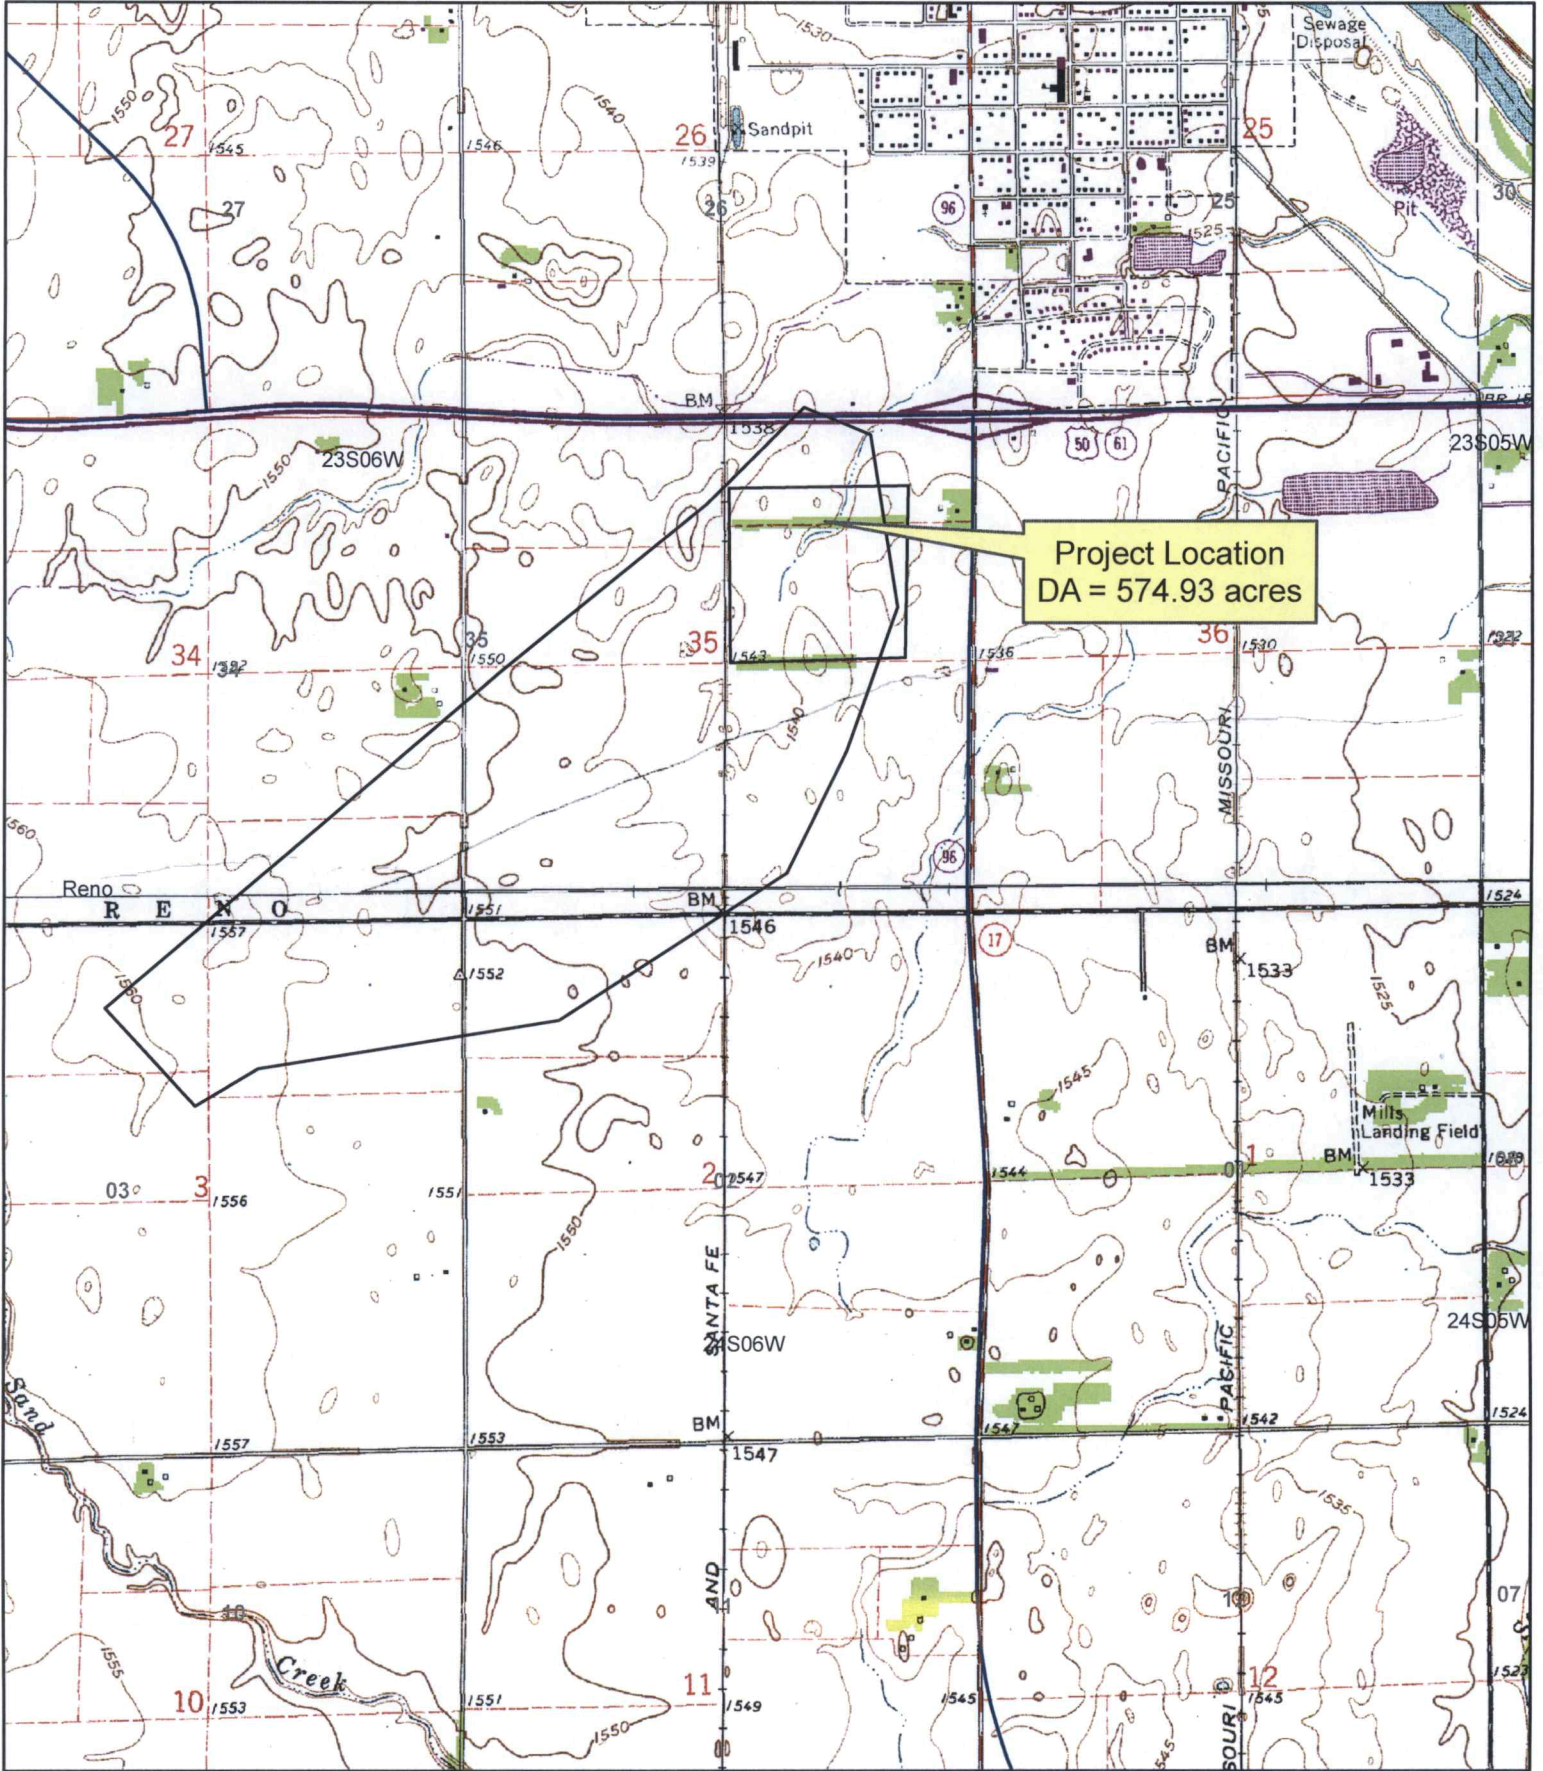1:24,000

2,500 0 2,500 5,000


SCANNED



FRONTIER COMMERCE PARK PHASE I - STREET IMPROVEMENTS SOUTH HUTCHINSON, KANSAS CED PROJ. NO. 20152287

INDEX

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2. Layout Sheet
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4. Pavement Joint Detail
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- 7.-11. Plan and Profiles (Street)
12. Plan and Profiles (North Subdivision Entrance)
- 13.-14. Plan and Profiles (Storm Sewer to Pond)
- 15.-16. Plan and Profiles (Ditch to RCB)
- 17.-18. Plan and Profiles (Cross Road Pipes)
19. Plan and Profiles (Southwest Channel)
20. Detention Pond
21. Plan and Profiles (Southeast Ditch)
22. Plan and Profiles (Southeast Storm Sewer)
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29. Traffic Control
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49. Cross-Sections (Southeast Ditch)
- 50.-52. Frontier Commerce Park Final Plat

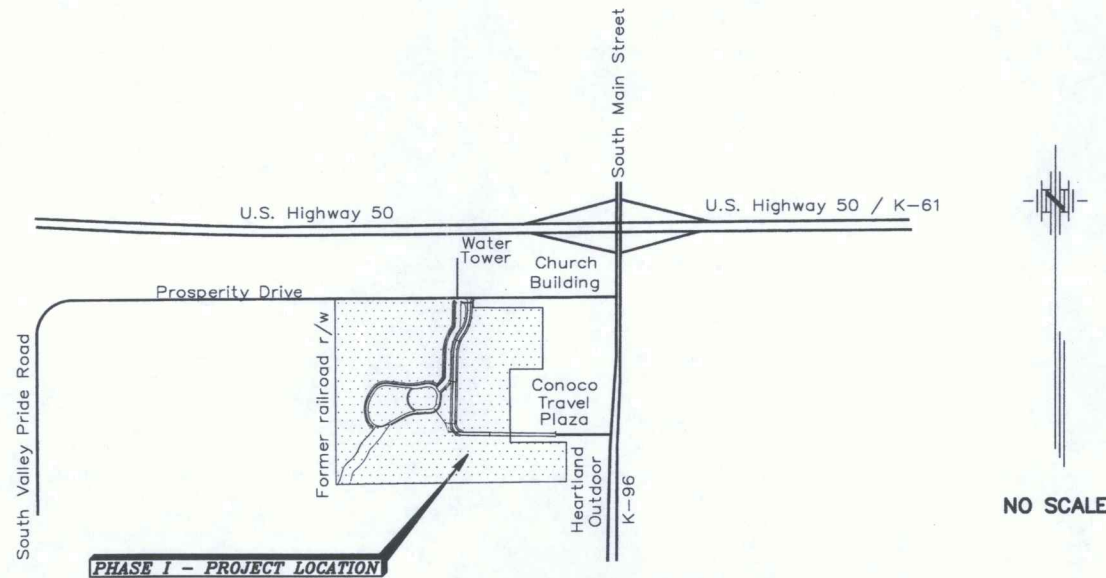

S O U T H H U T C H I N S O N
VICINITY MAP
(NOT TO SCALE)
2016

APPROXIMATE SUMMARY OF QUANTITIES

DESCRIPTION	TOTAL	UNITS
Common Excavation	38117	C.Y.
Compacted Fill(95% ASTM D-698)	16213	C.Y.
6" P.C. Concrete Pavement (4,000 psi)	6856	S.Y.
8" Reinforced Crushed Rock Base	8652	S.Y.
30" Standard Curb & Gutter(Layback?)	4441	L.F.
7" Reinforced Concrete Drive	67	S.Y.
Storm Sewer Manhole	4	Each
Type 22 Curb Inlets	10	Each
Inlet Hookup	10	Each
15" Storm Sewer Pipe(RCP) in place	270	L.F.
18" Storm Sewer Pipe(RCP) in place	1302	L.F.
24" Storm Sewer Pipe(RCP) in place	228	L.F.
30" Storm Sewer Pipe(RCP) in place	61	L.F.
15" Concrete End Section	3	Each
18" Concrete End Section	2	Each
24" Concrete End Section	2	Each
30 Concrete End Section	1	Each
12" Storm Sewer Pipe(CMP) in place	49	L.F.
24" Storm Sewer Pipe(CMP) in place	24	L.F.
12" CMP End Section	2	Each
24" CMP End Section	1	Each
12" CMP Flap Gate	2	Each
24" CMP Flap Gate	1	Each
24" Concrete Headwall w/ Flap Gate	2	Each
18" Concrete Headwall w/ Flap Gate	1	Each
Pond Sealing	1	L.S.
6" Rip-Rap(12" Depth)	182	S.Y.
12" Rip-Rap(24" Depth)	492	S.Y.
Pipeline Protection Structure(Sta.12+61)(100 l.f.)	1	Each
Pipeline Protection Structure(Sta.14+80)(10 l.f.)	1	Each
Pipeline Protection Structure(Sta.178+35)(50 l.f.)	1	Each
Erosion Control	1	L.S.
Temporary and Permanent Project Seeding(15.2 acres)	1	L.S.
Site Clearing and Restoration	1	L.S.

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CERTIFIED ENGINEERING DESIGN
1935 West Maple
Wichita, Kansas 67213

Harlan D. Foraker, P.E.



GARBER SURVEYING SERVICE, P.A.
2908 North Plum
Hutchinson, Kansas 67502

Daniel E. Garber, R.L.S.




WATER RESOURCES
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DEC 01 2016
KS DEPT OF AGRICULTURE

FRONTIER COMMERCE PARK TITLE SHEET	
STREET IMPROVEMENTS SOUTH HUTCHINSON, KANSAS	
CERTIFIED ENGINEERING DESIGN, I	
1935 WEST MAPLE WICHITA, KANSAS 67213 PH.(316)262-8808 FAX.(316)262-	
DESIGNED: HDF	SCALE: NONE
DRAWN: WJA	DATE: 11/15/2016
CHECKED: HDF	CED FILE: GSS G2014-767


FINAL PLAT FRONTIER COMMERCE PARK

A SUBDIVISION OF THE NORTHEAST QUARTER OF SECTION 35, TOWNSHIP 23 SOUTH, RANGE 6 WEST OF THE 6TH PRINCIPAL MERIDIAN
CITY OF SOUTH HUTCHINSON, RENO COUNTY, KANSAS,

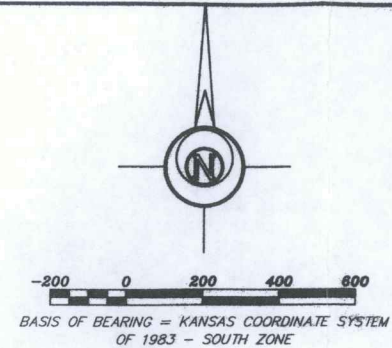

OWNER'S
CERTIFICATE
AND
SIGNATURE

- LEGEND**
- △ - Section Monument Found
 - ⊙ - 5/8" x 24" Iron Rebar Set w/G.S.S. Cap
 - M- - Fence
 - (C) - Calculated
 - (M) - Measured
 - (P) - Platted
 - (PS) - Previous Survey
 - P.O.B. - Point of Beginning
 - P.O.C. - Point of Commencement

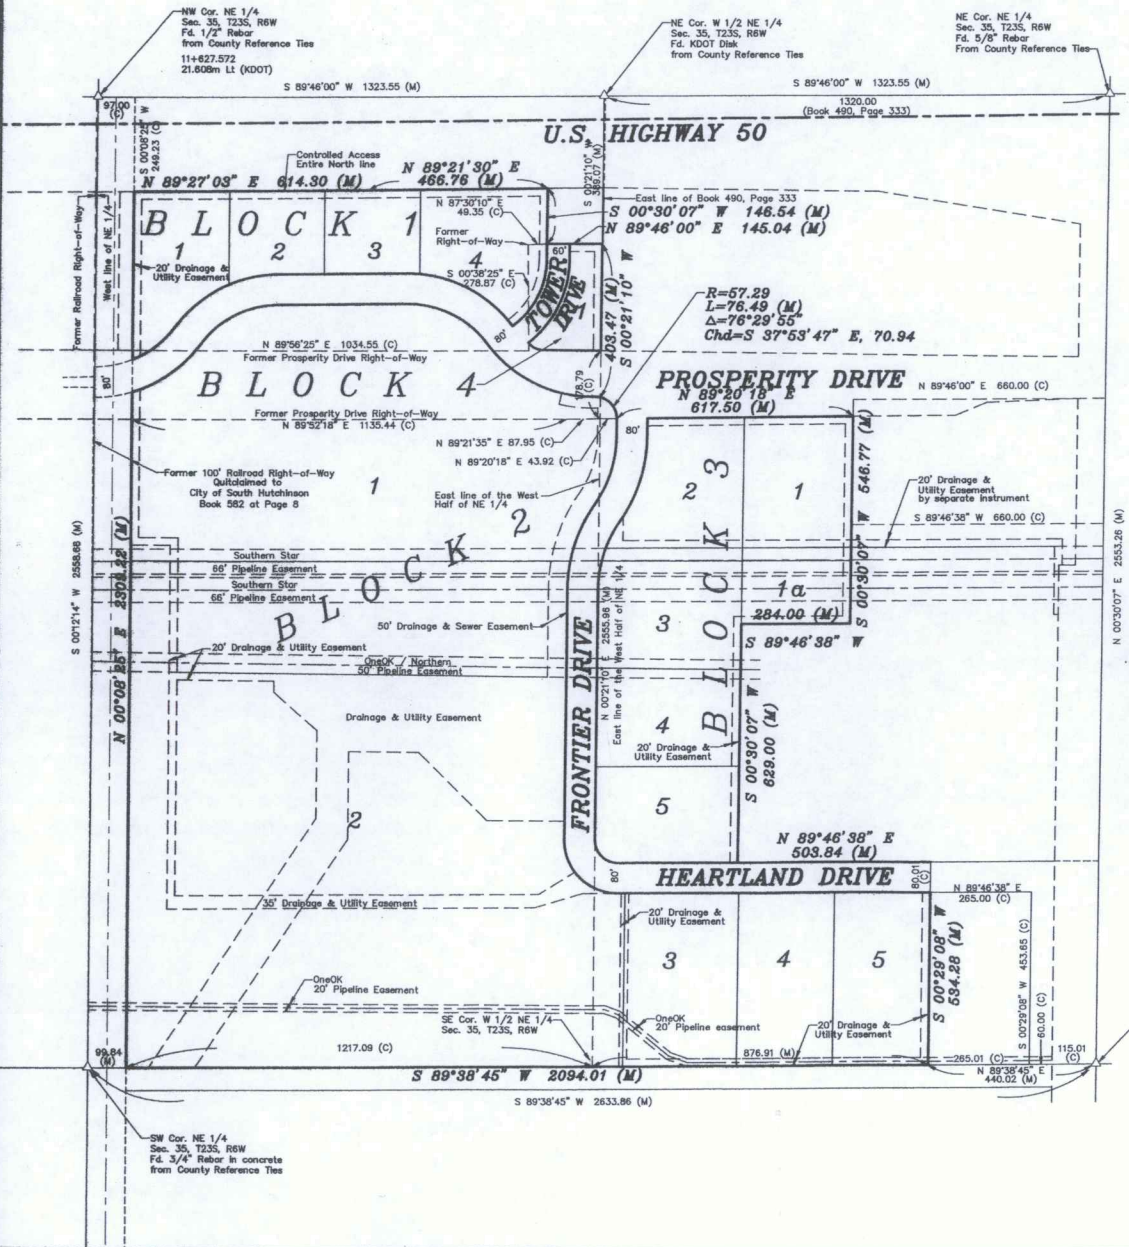

DESCRIPTION:

A portion of the Northeast Quarter of Section 35, Township 23 South, Range 6 West of the 6th Principal Meridian, Reno County, Kansas described as follows:

Commencing at the Northwest Corner of the Northeast Quarter of Section 35, Township 23 South, Range 6 West of the 6th Principal Meridian; thence with bearings based in the Kansas Coordinate System of 1983-South Zone, North 89°46'00" East along the North line of said Northwest Quarter 97.00 feet (County corner tie records) to the former East right-of-way line of the Burlington Northern and Santa Fe Railway Company (abandoned to the City of South Hutchinson by Quitclaim recorded in Book 582 at Page 8, Reno County deed records); thence South 00°08'25" West along said former East right-of-way line 249.23 feet to the South K-96 Highway right-of-way line for the Point of Beginning; thence North 89°27'03" East along said South right-of-way line 614.30 feet to a deflection point; thence North 89°21'30" East continuing along said South right-of-way line 466.76 feet to the West line of that certain parcel conveyed by deed recorded in Book 490 at Page 333, Reno County deed records; thence South 00°30'07" West along said West line 146.54 feet to the Southwest corner of said parcel; thence departing said West line North 89°46'00" East along the South line of said parcel 145.04 feet to the East line of the West Half of said Northeast Quarter; thence departing said South line South 00°21'10" West along said East line 403.47 feet to a point on a non-tangent curve; thence Southeast along said curve, said curve being concave to the Southwest and having a radius of 57.29 feet through central angle of 76°29'55" for an arc length of 76.49 feet, the chord of which bears South 37°53'47" East, 70.94 feet; thence North 89°20'18" East along the South right-of-way line of Prosperity Drive 617.50 feet; thence departing said South right-of-way line South 00°30'07" West 546.77 feet; thence South 89°46'38" West 284.00 feet; thence South 00°30'07" West 629.00 feet; thence North 89°46'38" East 503.84 feet; thence South 00°29'08" West 534.28 feet to the South line of said Northeast Quarter; thence South 89°38'45" West along said South line 2094.01 feet to the East line of said abandoned railroad right-of-way, thence North 00°08'25" East along said right-of-way line 2309.22 feet to the Point of Beginning containing 88.816 Acres subject to any easements of record.

OWNER'S CERTIFICATE

State of Kansas)
County of Reno) SS
I, Richard Grober, owner of the land described in the plat and have caused the same to be surveyed and subdivided as indicated thereon, for the uses and purposes therein set forth, and does hereby acknowledge and adopt the same under the title and date thereon indicated.

All streets shown on this plat are hereby dedicated to the public. An easement or license to the public to locate, construct and maintain or substitute the location, construction and maintenance of roads, water, gas, oil, telephone or required drainage channels or structures upon the areas marked for easements on this plat are hereby granted.

PREPARED BY:
Richard Grober
Richard Grober

NOTARY CERTIFICATE

State of Kansas)
County of Reno) SS
I, Cherie Bailey, a Notary Public in and for said County, in the State aforesaid, do hereby certify that Richard Grober, owner of the land described in the plat and have caused the same to be surveyed and subdivided as indicated thereon, for the uses and purposes therein set forth, and does hereby acknowledge and adopt the same under the title and date thereon indicated.

Given under my hand and Notarial Seal this 18th day of March, A.D., 2014

SOUTH HUTCHINSON CITY PLANNING COMMISSION CERTIFICATE

State of Kansas)
County of Reno) SS
Approved this 13 day of January, A.D., 2014

SOUTH HUTCHINSON CITY PLANNING COMMISSION

James Dull
Chairman
Attest: James Dull
Secretary

SOUTH HUTCHINSON CITY COUNCIL CERTIFICATE

State of Kansas)
County of Reno) SS
Approved this 21 day of January, A.D., 2014

Mayor: James Dull
Attest: Dennis McCre
City Clerk

COUNTY SURVEYOR'S CERTIFICATE

State of Kansas)
County of Reno) SS

I hereby certify that I have reviewed the surveyed plat and certify said plat to be in compliance with the requirements of K.S.A. 58-2005.

Richard Grober
County Surveyor

SURVEYOR'S CERTIFICATE

State of Kansas)
County of Reno) SS
I, the undersigned, do hereby certify that I am a Registered Land Surveyor in the State of Kansas, with the experience and proficiency in land surveying, that the heretofore described property was surveyed and subdivided by me, or under my supervision; that all subdivisions regulations of the City of South Hutchinson, Kansas have been complied with in the preparation of this plat and that all the monuments shown herein actually exist and their positions are correctly shown to the best of my knowledge and belief.

9-14-2012
Date of Survey



Given under my hand and seal at Hutchinson, Kansas this 18th day of March, A.D., 2014

REGISTER OF DEEDS CERTIFICATE:

STATE OF KANSAS)
COUNTY OF RENO) SS
BONNIE RUEBKKE
RENO COUNTY
REGISTER OF DEEDS
HUTCHINSON KS 67501

Recorded this 14th day of April, 2014 A.D., at 9:00 AM P.M.
Fee Paid: 60.00 Filed in plot File: 8 Sleeve: 184 A

Bonnie Ruebke
Bonnie Ruebke, Register of Deeds

Entered in the transfer record this 14th day of April, 2014
Donna Patton Deputy County Clerk

CLOSURE TABLE

Northing = -0.0020
Easting = 0.0100
Pracolon = 9371.21 / 0.0102 = 1,918,746

Prepared For: **FRONTIER COMMERCE PARK**

Prepared By: **Garber Surveying Service, P.A.**

GSS HUTCHINSON (Main Office) 2988 North Platte St. 67502 Ph. 620-465-7833 Fax 620-465-7481
MURKINSON (Branch Office) 115 East Main St. 67469 Ph. 620-341-4441 Fax 620-341-4458
NEWTON (Branch Office) 111 North Poplar St. 67114 Ph. 316-281-5855 Fax 316-281-5873

Drawn By: DWJ Scale: 1"=100' Date of Field Work: Sept. 14, 2012 Job No: G2012-431
Checked By: DEG Date: 02/27/2014 Sheet 1 of 3 Sheets


WATER RESOURCES RECEIVED

DEC 02 2016

KS DEPT OF AGRICULTURE

SCANNED

FRONTIER COMMERCE PARK
FINAL PLAT
STREET IMPROVEMENTS
SOUTH HUTCHINSON, KANSAS
CERTIFIED ENGINEERING DESIGN, P
1935 WEST MAPLE
WICHITA, KANSAS 67213
PH.(316)262-8808 FAX.(316)262-

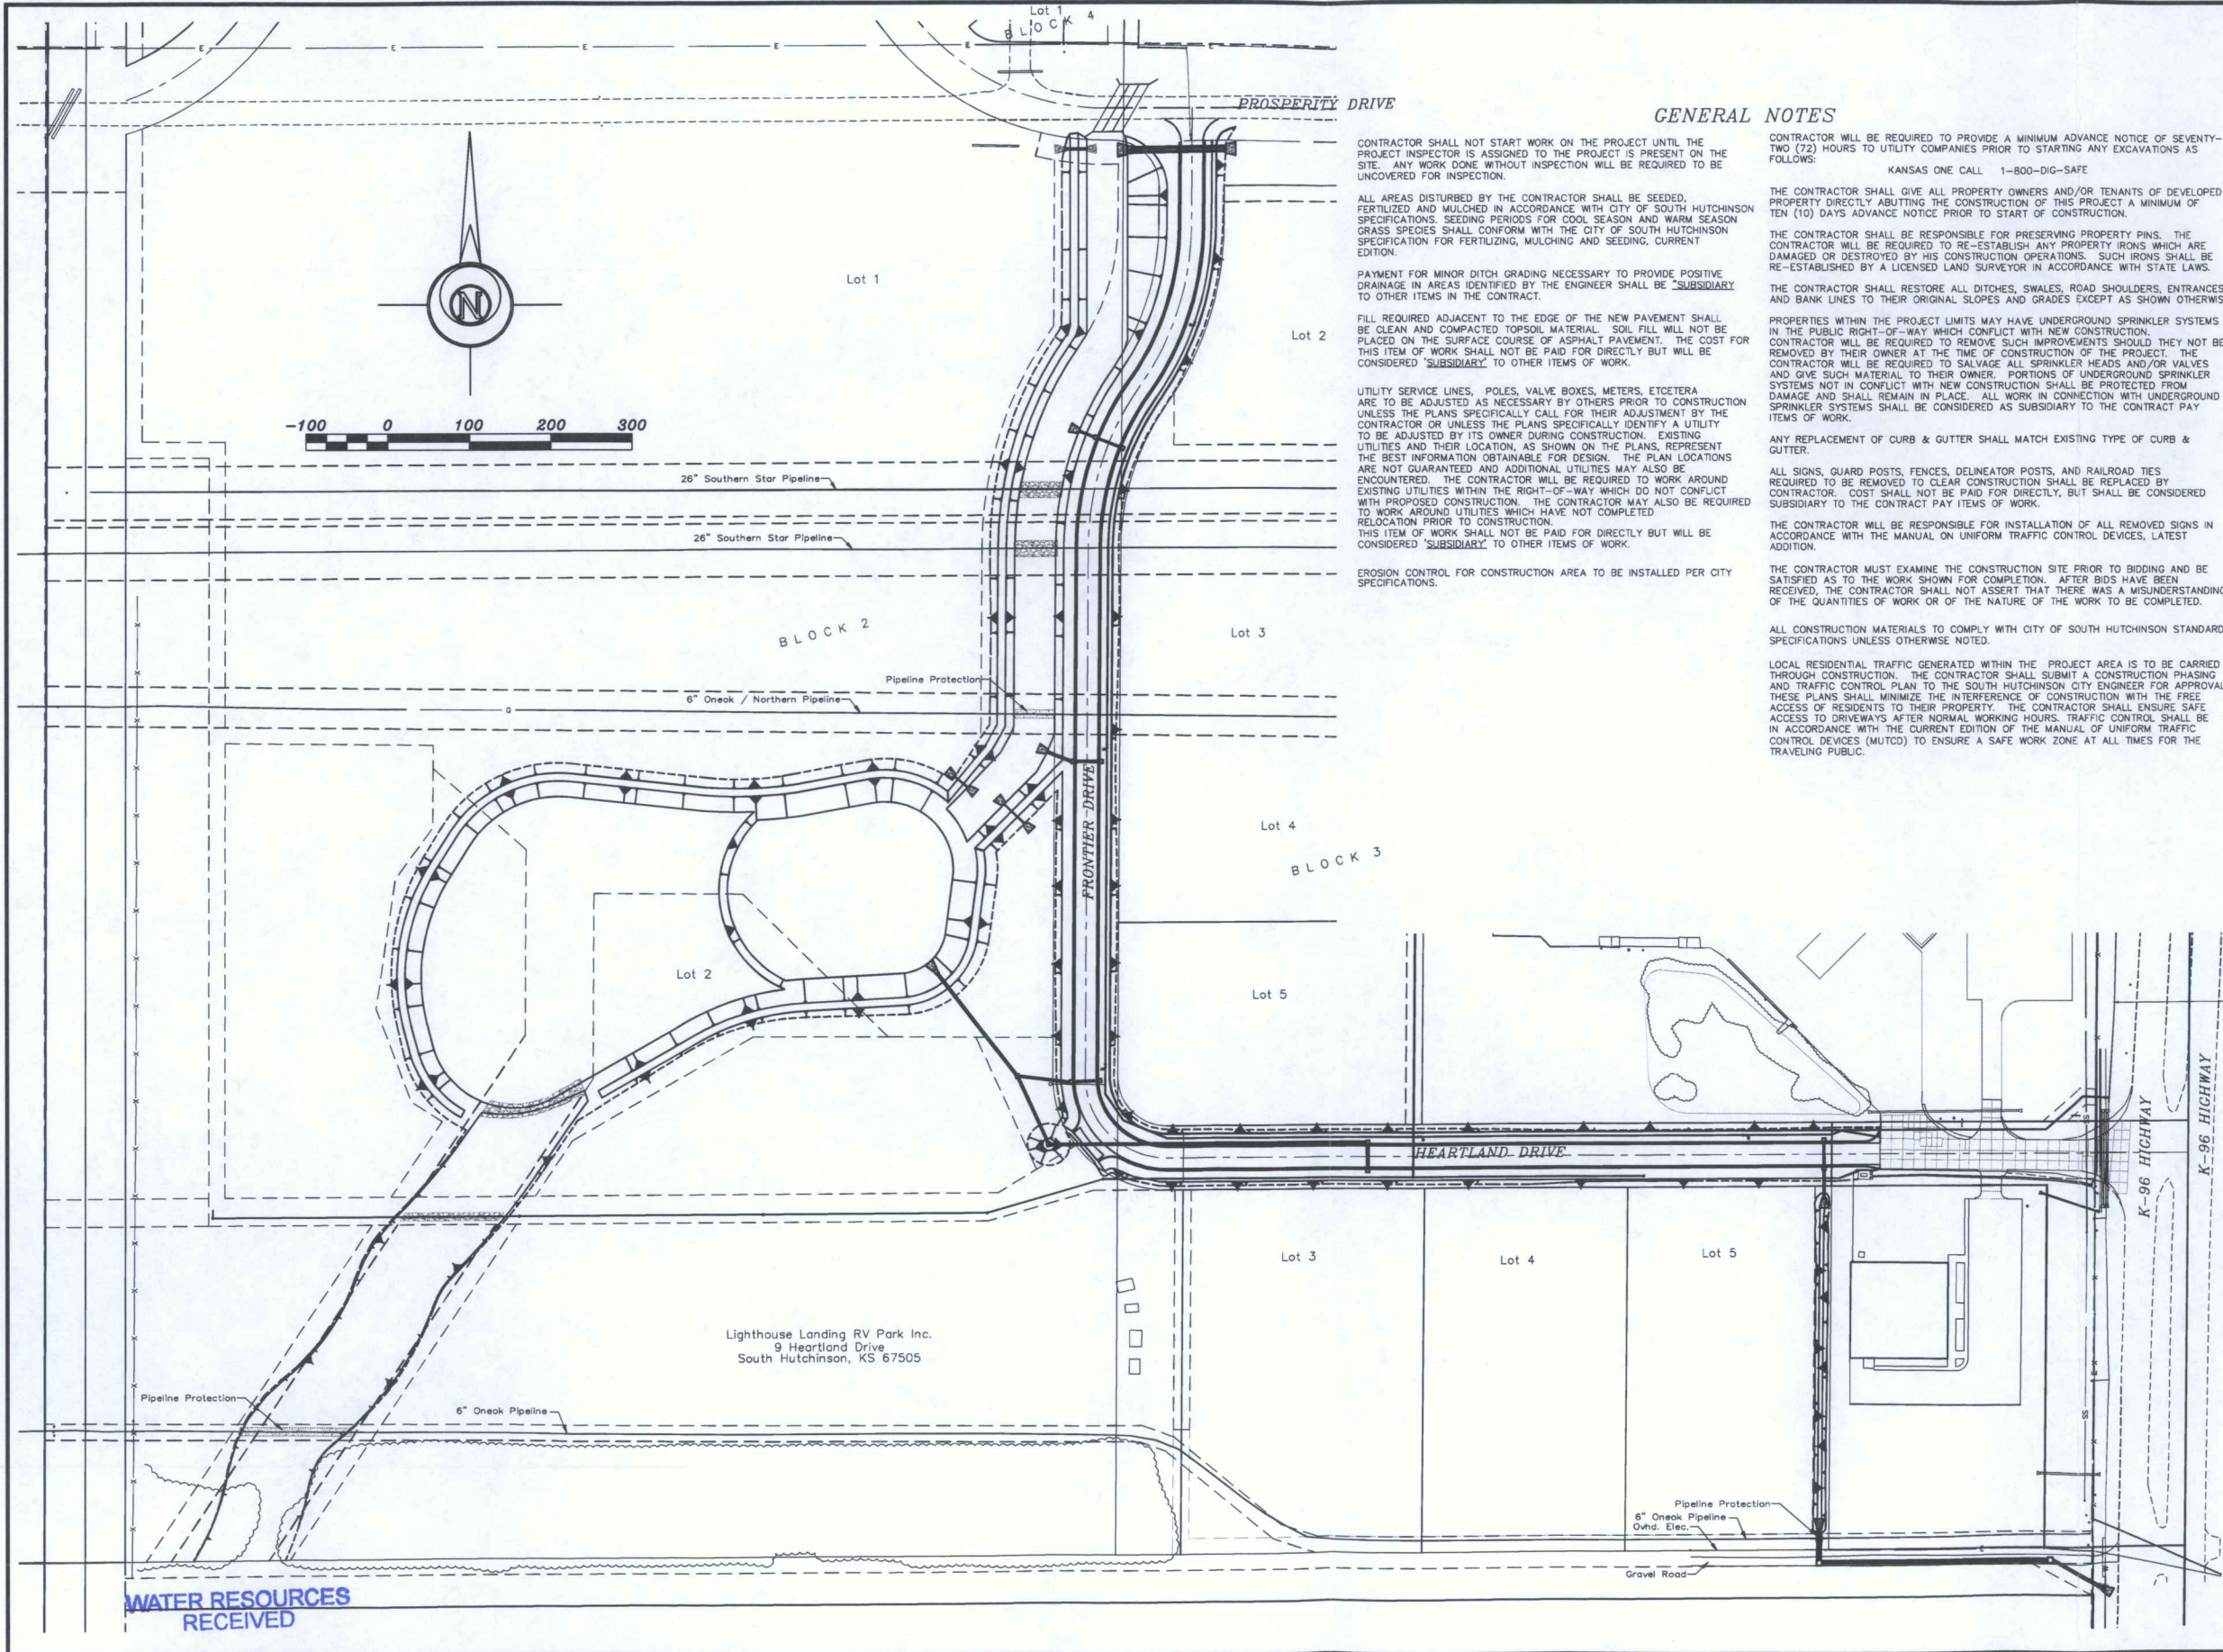

GENERAL NOTES

CONTRACTOR SHALL NOT START WORK ON THE PROJECT UNTIL THE PROJECT INSPECTOR IS ASSIGNED TO THE PROJECT IS PRESENT ON THE SITE. ANY WORK DONE WITHOUT INSPECTION WILL BE REQUIRED TO BE UNCOVERED FOR INSPECTION.

ALL AREAS DISTURBED BY THE CONTRACTOR SHALL BE SEEDED, FERTILIZED AND MULCHED IN ACCORDANCE WITH CITY OF SOUTH HUTCHINSON SPECIFICATIONS. SEEDING PERIODS FOR COOL SEASON AND WARM SEASON GRASS SPECIES SHALL CONFORM WITH THE CITY OF SOUTH HUTCHINSON SPECIFICATION FOR FERTILIZING, MULCHING AND SEEDING, CURRENT EDITION.

PAYMENT FOR MINOR DITCH GRADING NECESSARY TO PROVIDE POSITIVE DRAINAGE IN AREAS IDENTIFIED BY THE ENGINEER SHALL BE SUBSIDIARY TO OTHER ITEMS IN THE CONTRACT.

FILL REQUIRED ADJACENT TO THE EDGE OF THE NEW PAVEMENT SHALL BE CLEAN AND COMPACTED TOPSOIL MATERIAL. SOIL FILL WILL NOT BE PLACED ON THE SURFACE COURSE OF ASPHALT PAVEMENT. THE COST FOR THIS ITEM OF WORK SHALL NOT BE PAID FOR DIRECTLY BUT WILL BE CONSIDERED SUBSIDIARY TO OTHER ITEMS OF WORK.

UTILITY SERVICE LINES, POLES, VALVE BOXES, METERS, ETCETERA ARE TO BE ADJUSTED AS NECESSARY BY OTHERS PRIOR TO CONSTRUCTION UNLESS THE PLANS SPECIFICALLY CALL FOR THEIR ADJUSTMENT BY THE CONTRACTOR OR UNLESS THE PLANS SPECIFICALLY IDENTIFY A UTILITY TO BE ADJUSTED BY ITS OWNER DURING CONSTRUCTION. EXISTING UTILITIES AND THEIR LOCATION, AS SHOWN ON THE PLANS, REPRESENT THE BEST INFORMATION OBTAINABLE FOR DESIGN. THE PLAN LOCATIONS ARE NOT GUARANTEED AND ADDITIONAL UTILITIES MAY ALSO BE ENCOUNTERED. THE CONTRACTOR WILL BE REQUIRED TO WORK AROUND EXISTING UTILITIES WITHIN THE RIGHT-OF-WAY WHICH DO NOT CONFLICT WITH PROPOSED CONSTRUCTION. THE CONTRACTOR MAY ALSO BE REQUIRED TO WORK AROUND UTILITIES WHICH HAVE NOT COMPLETED RELOCATION PRIOR TO CONSTRUCTION. THIS ITEM OF WORK SHALL NOT BE PAID FOR DIRECTLY BUT WILL BE CONSIDERED SUBSIDIARY TO OTHER ITEMS OF WORK.

EROSION CONTROL FOR CONSTRUCTION AREA TO BE INSTALLED PER CITY SPECIFICATIONS.

CONTRACTOR WILL BE REQUIRED TO PROVIDE A MINIMUM ADVANCE NOTICE OF SEVENTY-TWO (72) HOURS TO UTILITY COMPANIES PRIOR TO STARTING ANY EXCAVATIONS AS FOLLOWS:
KANSAS ONE CALL 1-800-DIG-SAFE

THE CONTRACTOR SHALL GIVE ALL PROPERTY OWNERS AND/OR TENANTS OF DEVELOPED PROPERTY DIRECTLY ABUTTING THE CONSTRUCTION OF THIS PROJECT A MINIMUM OF TEN (10) DAYS ADVANCE NOTICE PRIOR TO START OF CONSTRUCTION.

THE CONTRACTOR SHALL BE RESPONSIBLE FOR PRESERVING PROPERTY PINS. THE CONTRACTOR WILL BE REQUIRED TO RE-ESTABLISH ANY PROPERTY IRONS WHICH ARE DAMAGED OR DESTROYED BY HIS CONSTRUCTION OPERATIONS. SUCH IRONS SHALL BE RE-ESTABLISHED BY A LICENSED LAND SURVEYOR IN ACCORDANCE WITH STATE LAWS.

THE CONTRACTOR SHALL RESTORE ALL DITCHES, SWALES, ROAD SHOULDERS, ENTRANCES AND BANK LINES TO THEIR ORIGINAL SLOPES AND GRADES EXCEPT AS SHOWN OTHERWISE.

PROPERTIES WITHIN THE PROJECT LIMITS MAY HAVE UNDERGROUND SPRINKLER SYSTEMS IN THE PUBLIC RIGHT-OF-WAY WHICH CONFLICT WITH NEW CONSTRUCTION. CONTRACTOR WILL BE REQUIRED TO REMOVE SUCH IMPROVEMENTS SHOULD THEY NOT BE REMOVED BY THEIR OWNER AT THE TIME OF CONSTRUCTION OF THE PROJECT. THE CONTRACTOR WILL BE REQUIRED TO SALVAGE ALL SPRINKLER HEADS AND/OR VALVES AND GIVE SUCH MATERIAL TO THEIR OWNER. PORTIONS OF UNDERGROUND SPRINKLER SYSTEMS NOT IN CONFLICT WITH NEW CONSTRUCTION SHALL BE PROTECTED FROM DAMAGE AND SHALL REMAIN IN PLACE. ALL WORK IN CONNECTION WITH UNDERGROUND SPRINKLER SYSTEMS SHALL BE CONSIDERED AS SUBSIDIARY TO THE CONTRACT PAY ITEMS OF WORK.

ANY REPLACEMENT OF CURB & GUTTER SHALL MATCH EXISTING TYPE OF CURB & GUTTER.



ALL SIGNS, GUARD POSTS, FENCES, DELINEATOR POSTS, AND RAILROAD TIES REQUIRED TO BE REMOVED TO CLEAR CONSTRUCTION SHALL BE REPLACED BY CONTRACTOR. COST SHALL NOT BE PAID FOR DIRECTLY, BUT SHALL BE CONSIDERED SUBSIDIARY TO THE CONTRACT PAY ITEMS OF WORK.

THE CONTRACTOR WILL BE RESPONSIBLE FOR INSTALLATION OF ALL REMOVED SIGNS IN ACCORDANCE WITH THE MANUAL ON UNIFORM TRAFFIC CONTROL DEVICES, LATEST EDITION.

THE CONTRACTOR MUST EXAMINE THE CONSTRUCTION SITE PRIOR TO BIDDING AND BE SATISFIED AS TO THE WORK SHOWN FOR COMPLETION. AFTER BIDS HAVE BEEN RECEIVED, THE CONTRACTOR SHALL NOT ASSERT THAT THERE WAS A MISUNDERSTANDING OF THE QUANTITIES OF WORK OR OF THE NATURE OF THE WORK TO BE COMPLETED.

ALL CONSTRUCTION MATERIALS TO COMPLY WITH CITY OF SOUTH HUTCHINSON STANDARD SPECIFICATIONS UNLESS OTHERWISE NOTED.

LOCAL RESIDENTIAL TRAFFIC GENERATED WITHIN THE PROJECT AREA IS TO BE CARRIED THROUGH CONSTRUCTION. THE CONTRACTOR SHALL SUBMIT A CONSTRUCTION PHASING AND TRAFFIC CONTROL PLAN TO THE SOUTH HUTCHINSON CITY ENGINEER FOR APPROVAL. THESE PLANS SHALL MINIMIZE THE INTERFERENCE OF CONSTRUCTION WITH THE FREE ACCESS OF RESIDENTS TO THEIR PROPERTY. THE CONTRACTOR SHALL ENSURE SAFE ACCESS TO DRIVEWAYS AFTER NORMAL WORKING HOURS. TRAFFIC CONTROL SHALL BE IN ACCORDANCE WITH THE CURRENT EDITION OF THE MANUAL OF UNIFORM TRAFFIC CONTROL DEVICES (MUTCD) TO ENSURE A SAFE WORK ZONE AT ALL TIMES FOR THE TRAVELING PUBLIC.

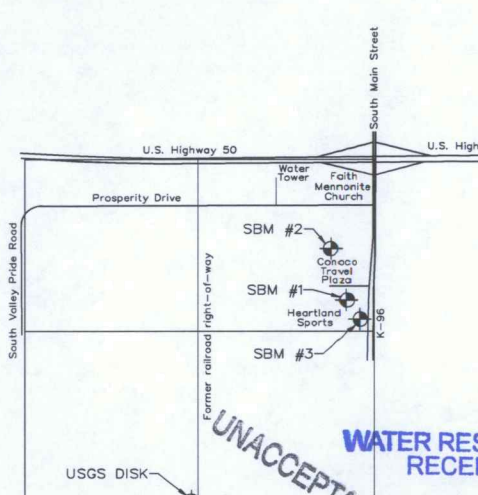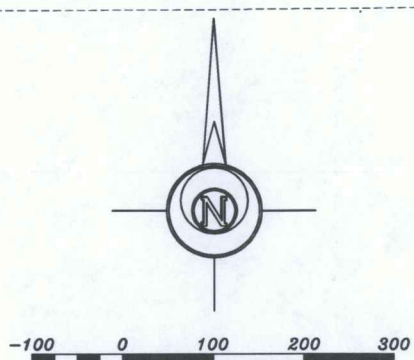

VERTICAL AND HORIZONTAL PROJECT CONTROL

N=1798070.7750 E=1470973.5000
USGS Azimuth Mark disk set in concrete post stamped "Fair located 27 feet North of the centerline of West Morgan Avenue opp 1/2 mile West of K-61 and 50 feet West of the former AT&SF rail vacated & razed). Elevation=1546.73

SBM #1 N=1801078.7487 E=1473213.7076
Square cut on the Southwest corner of a concrete pad for a box that is 163ft west of the entrance to Heartland Outdoor Store. Elevation=1538.65


SBM #2 N=1801844.4099 E=1472976.1589
Blue copped rebar in concrete 167ft West and 84ft North of Northeast corner of the Conoco Plaza Go truck parking lot. Elevation=1540.26

SBM #3 N=1800795.5778 E=1473408.4049
Blue square cut in the South edge of the concrete and 205 of the Southwest corner of the Heartland Outdoor concrete parking lot. Elevation=1537.11

FRONTIER COMMERCE PARK LAYOUT SHEET
STREET IMPROVEMENTS
SOUTH HUTCHINSON, KANSAS
CERTIFIED ENGINEERING DESIGN
CED
1935 WEST MAPLE
WICHITA, KANSAS 67213
PH.(316)262-8808 FAX.(316)262-8808

DESIGNED: HDF	SCALE: 1"=100'
DRAWN: WJA	DATE: 11/15/2016
CHECKED: HDF	CED FILE: GSS G2014-767


WATER RESOURCES RECEIVED
DEC 02 2016
KS DEPT. OF AGRICULTURE

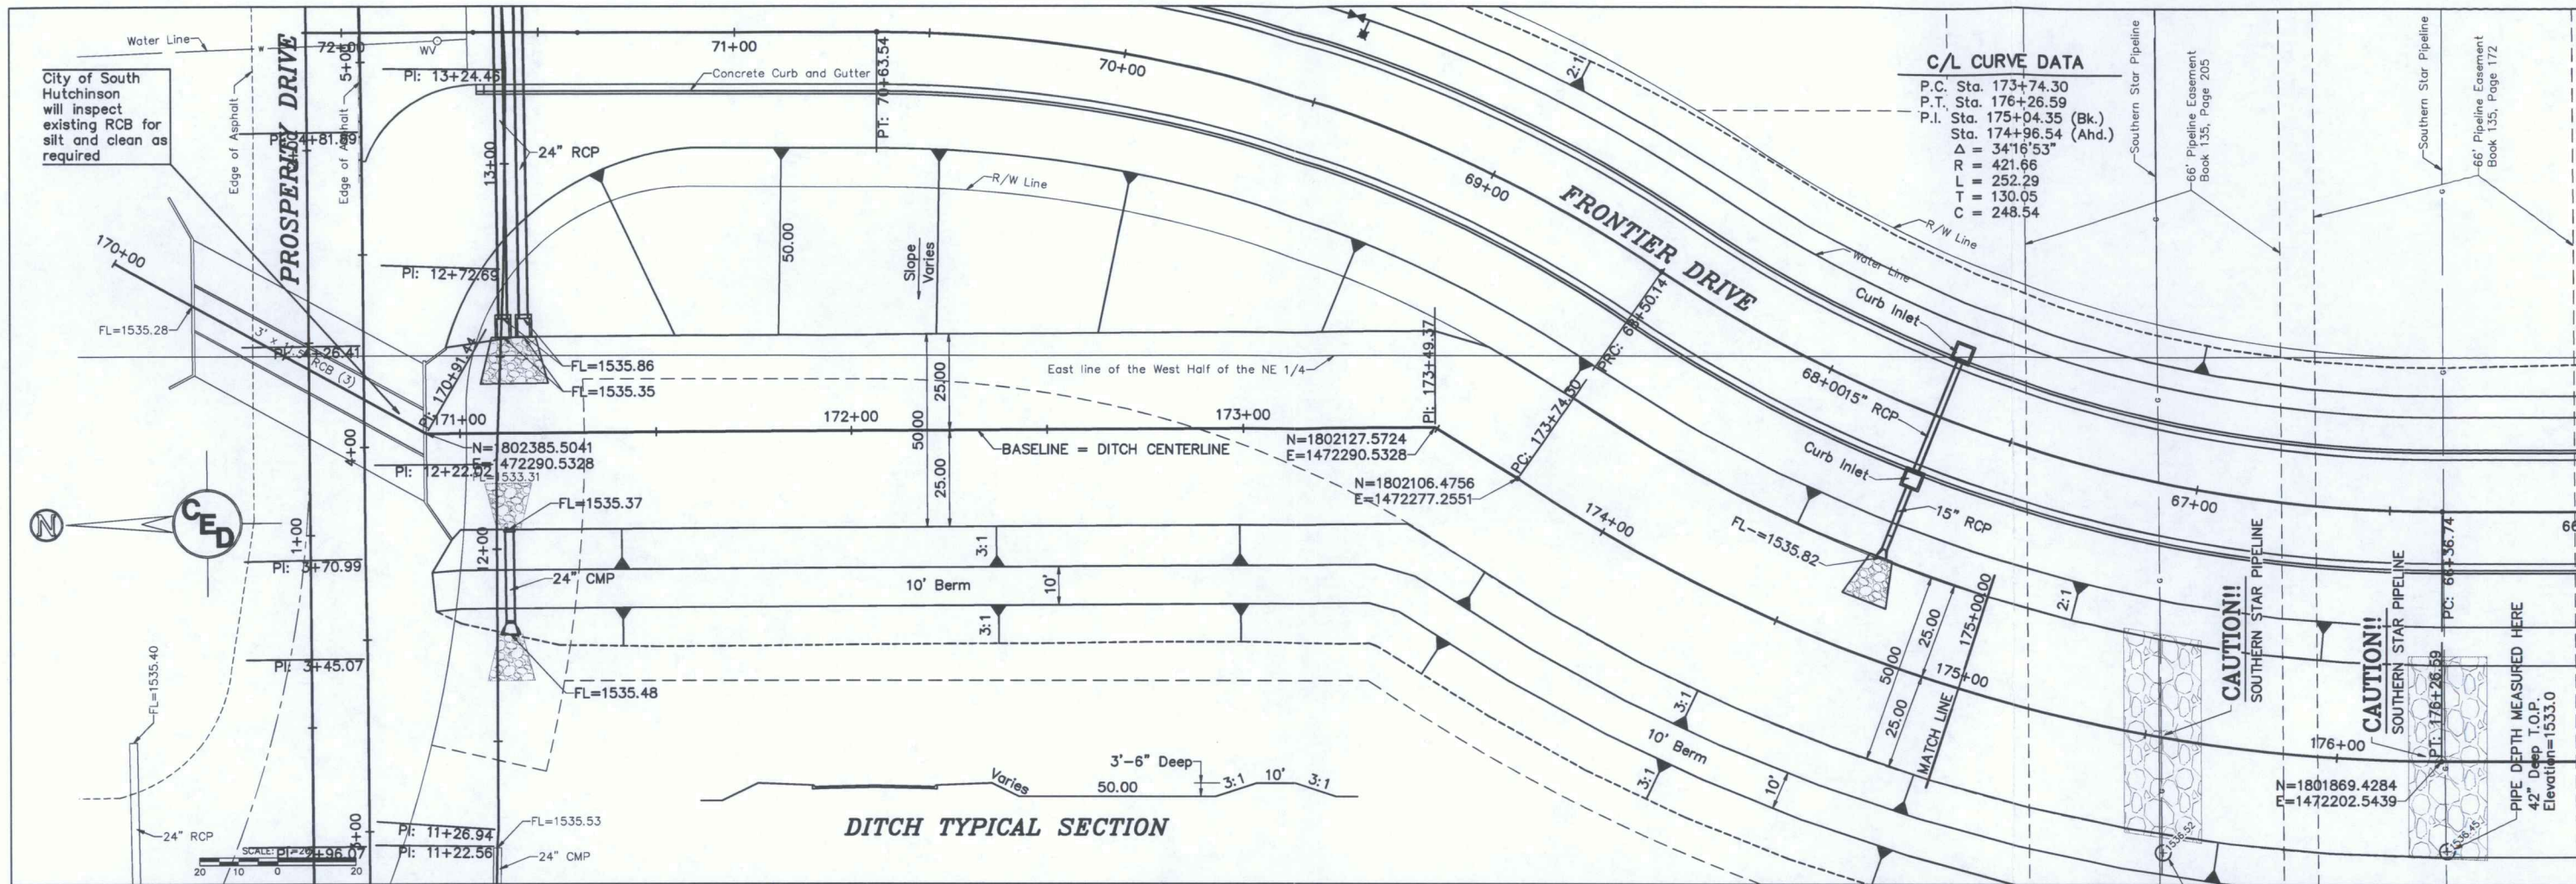

C/L CURVE DATA

P.C. Sta.	173+74.30
P.T. Sta.	176+26.59
P.I. Sta.	175+04.35 (Bk.)
Sta.	174+96.54 (Ahd.)
Δ	$34^{\circ}16'53''$
R	421.66
L	252.29
T	130.05
C	248.54

DITCH TYPICAL SECTION

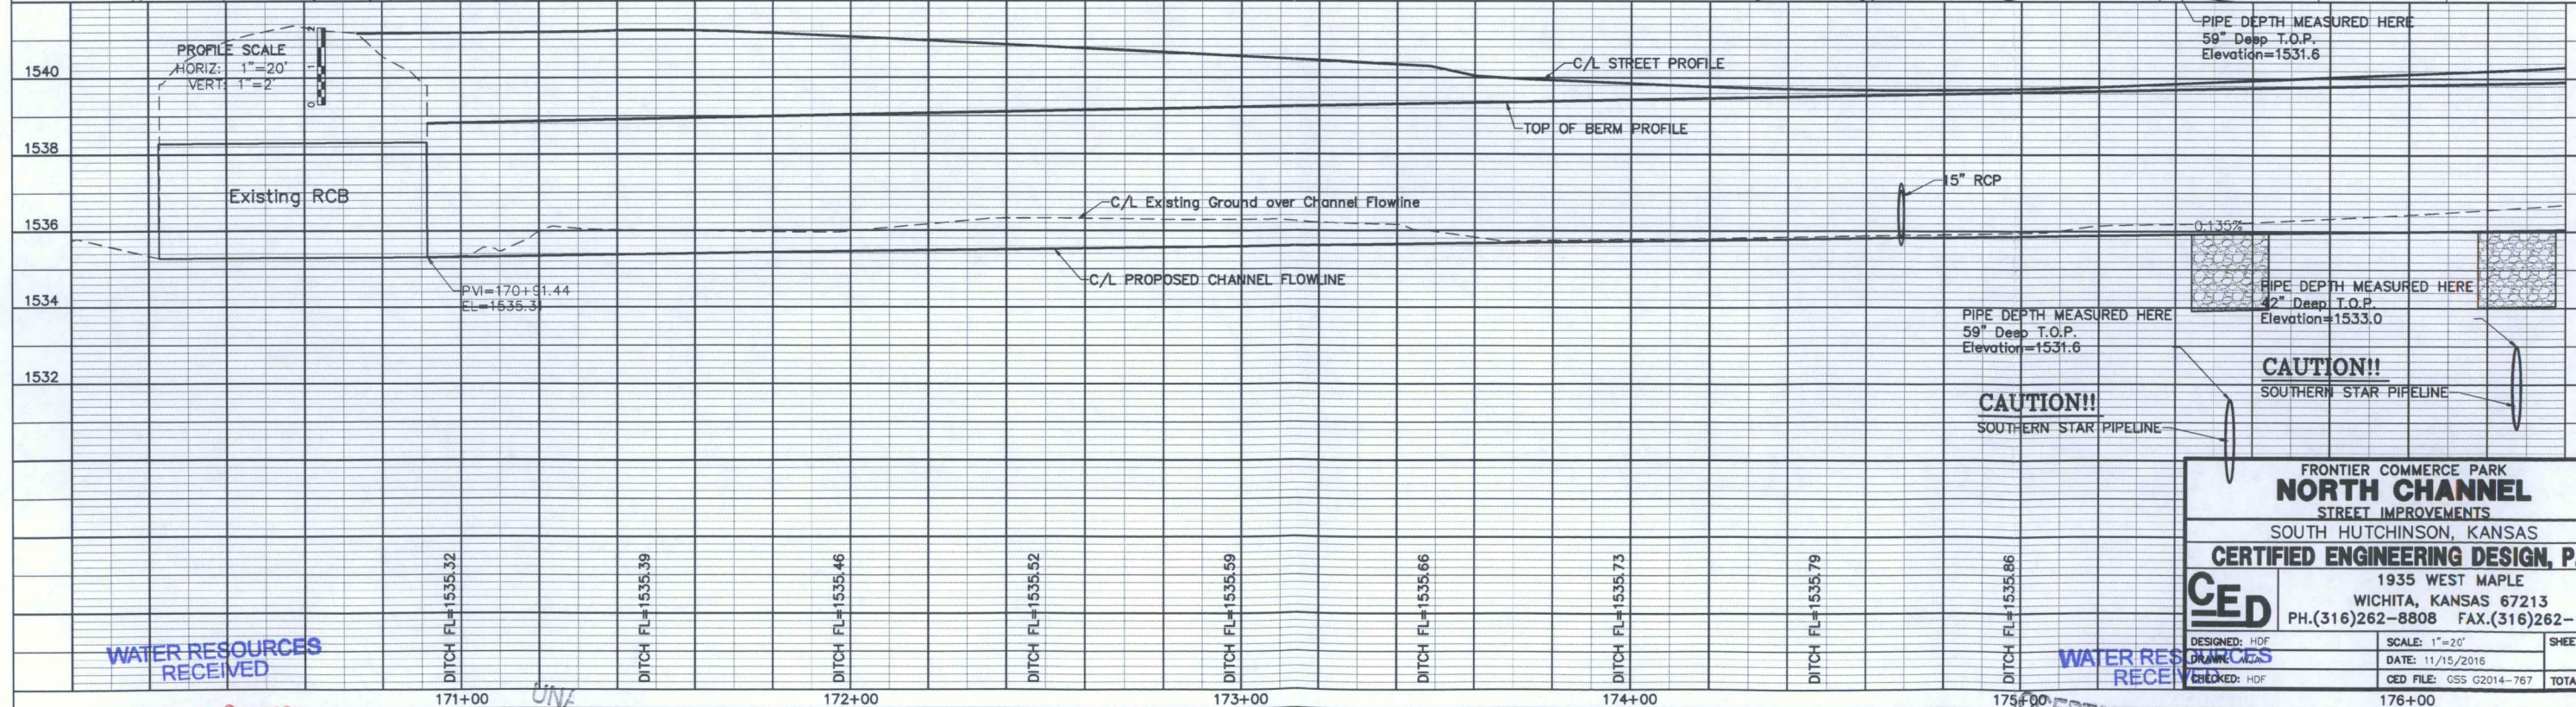

FRONTIER COMMERCE PARK
NORTH CHANNEL
 STREET IMPROVEMENTS
 SOUTH HUTCHINSON, KANSAS
CERTIFIED ENGINEERING DESIGN, P.A.
 1935 WEST MAPLE
 WICHITA, KANSAS 67213
 PH.(316)262-8808 FAX.(316)262-1000

DESIGNED: HDF	SCALE: 1"=20'	SHEET
DRAWN: CEA	DATE: 11/15/2016	TOTAL
CHECKED: HDF	GED FILE: GSS G2014-767	

WATER RESOURCES RECEIVED


WATER RESOURCES RECEIVED

DEC 02 2016


KS DEPT. OF AGRICULTURE

ACCEPTABLE FOR PRIORITY
 DEC 01 2016
 KS DEPT OF AGRICULTURE


SCANNED

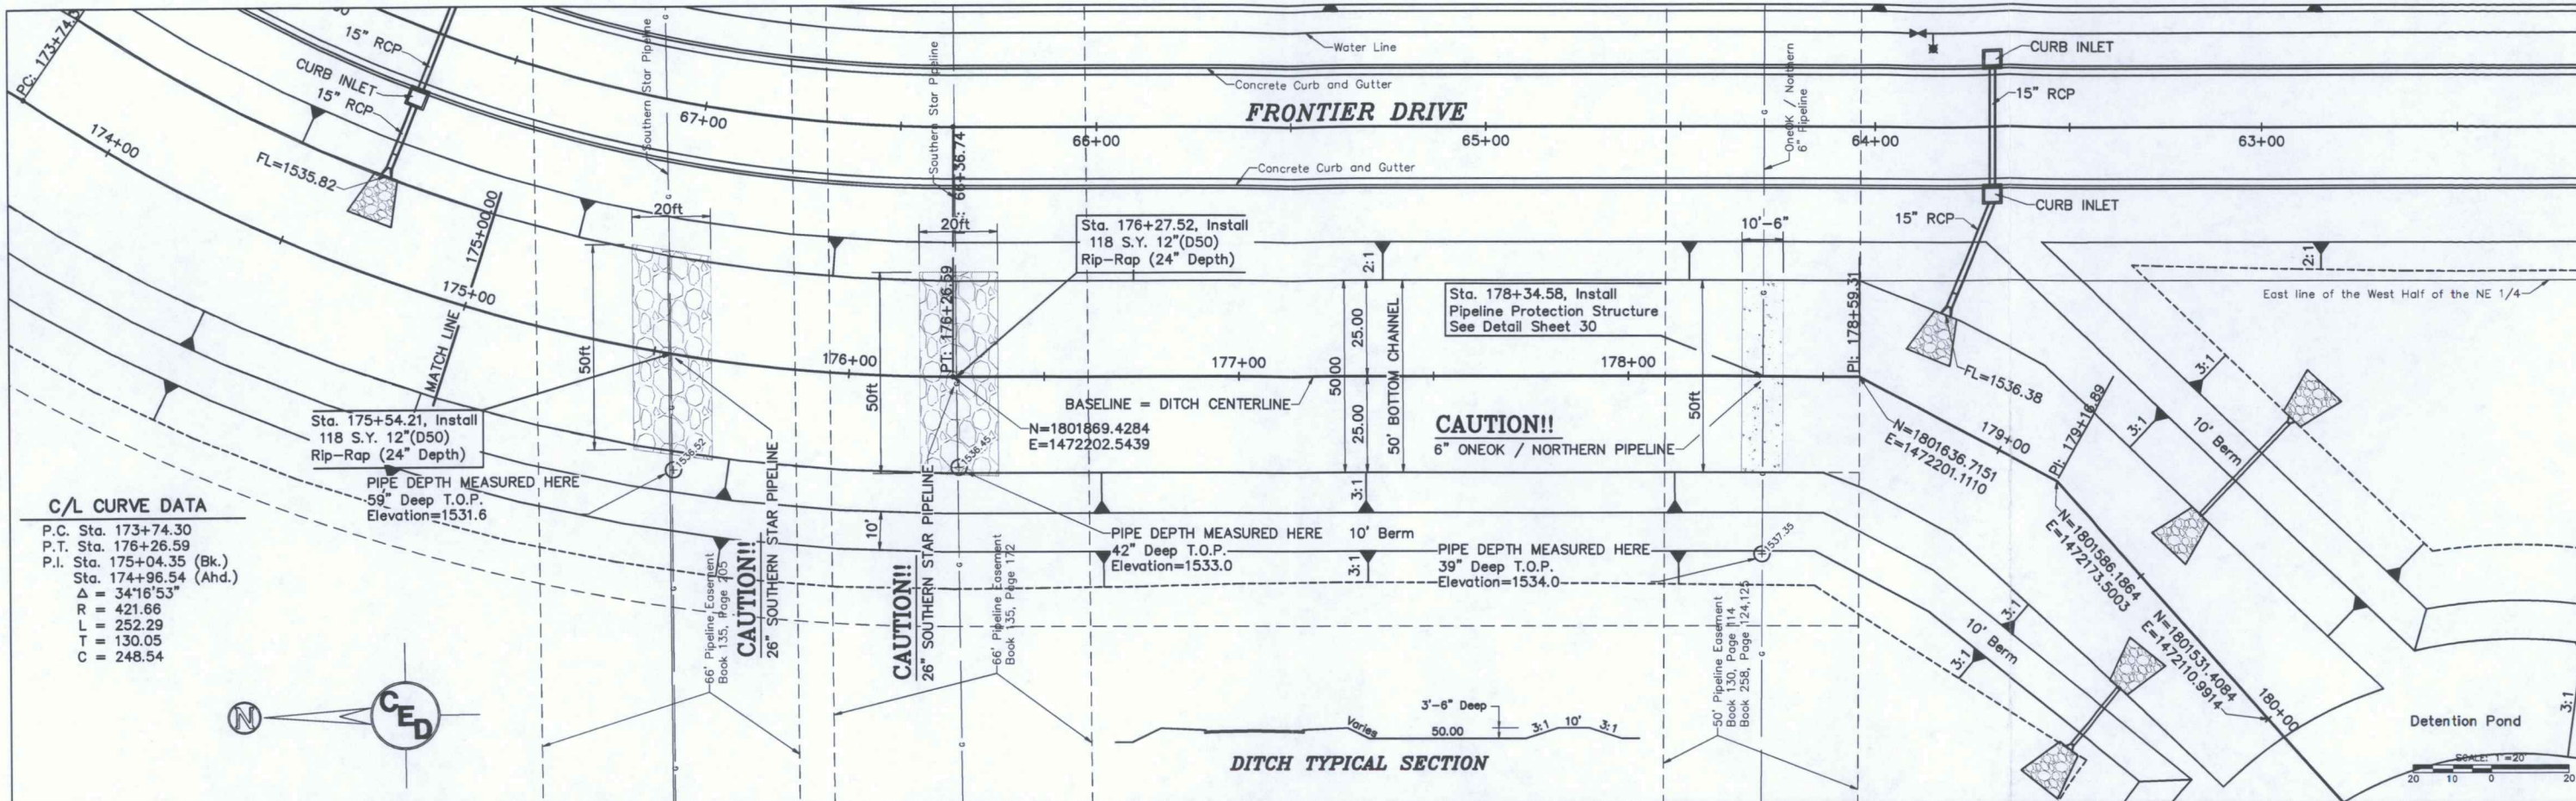

C/L CURVE DATA
 P.C. Sta. 173+74.30
 P.T. Sta. 176+26.59
 P.I. Sta. 175+04.35 (Bk.)
 Sta. 174+96.54 (Ahd.)
 $\Delta = 34^{\circ}16'53''$
 $R = 421.66$
 $L = 252.29$
 $T = 130.05$
 $C = 248.54$

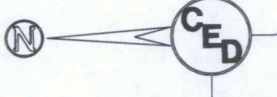

DITCH TYPICAL SECTION

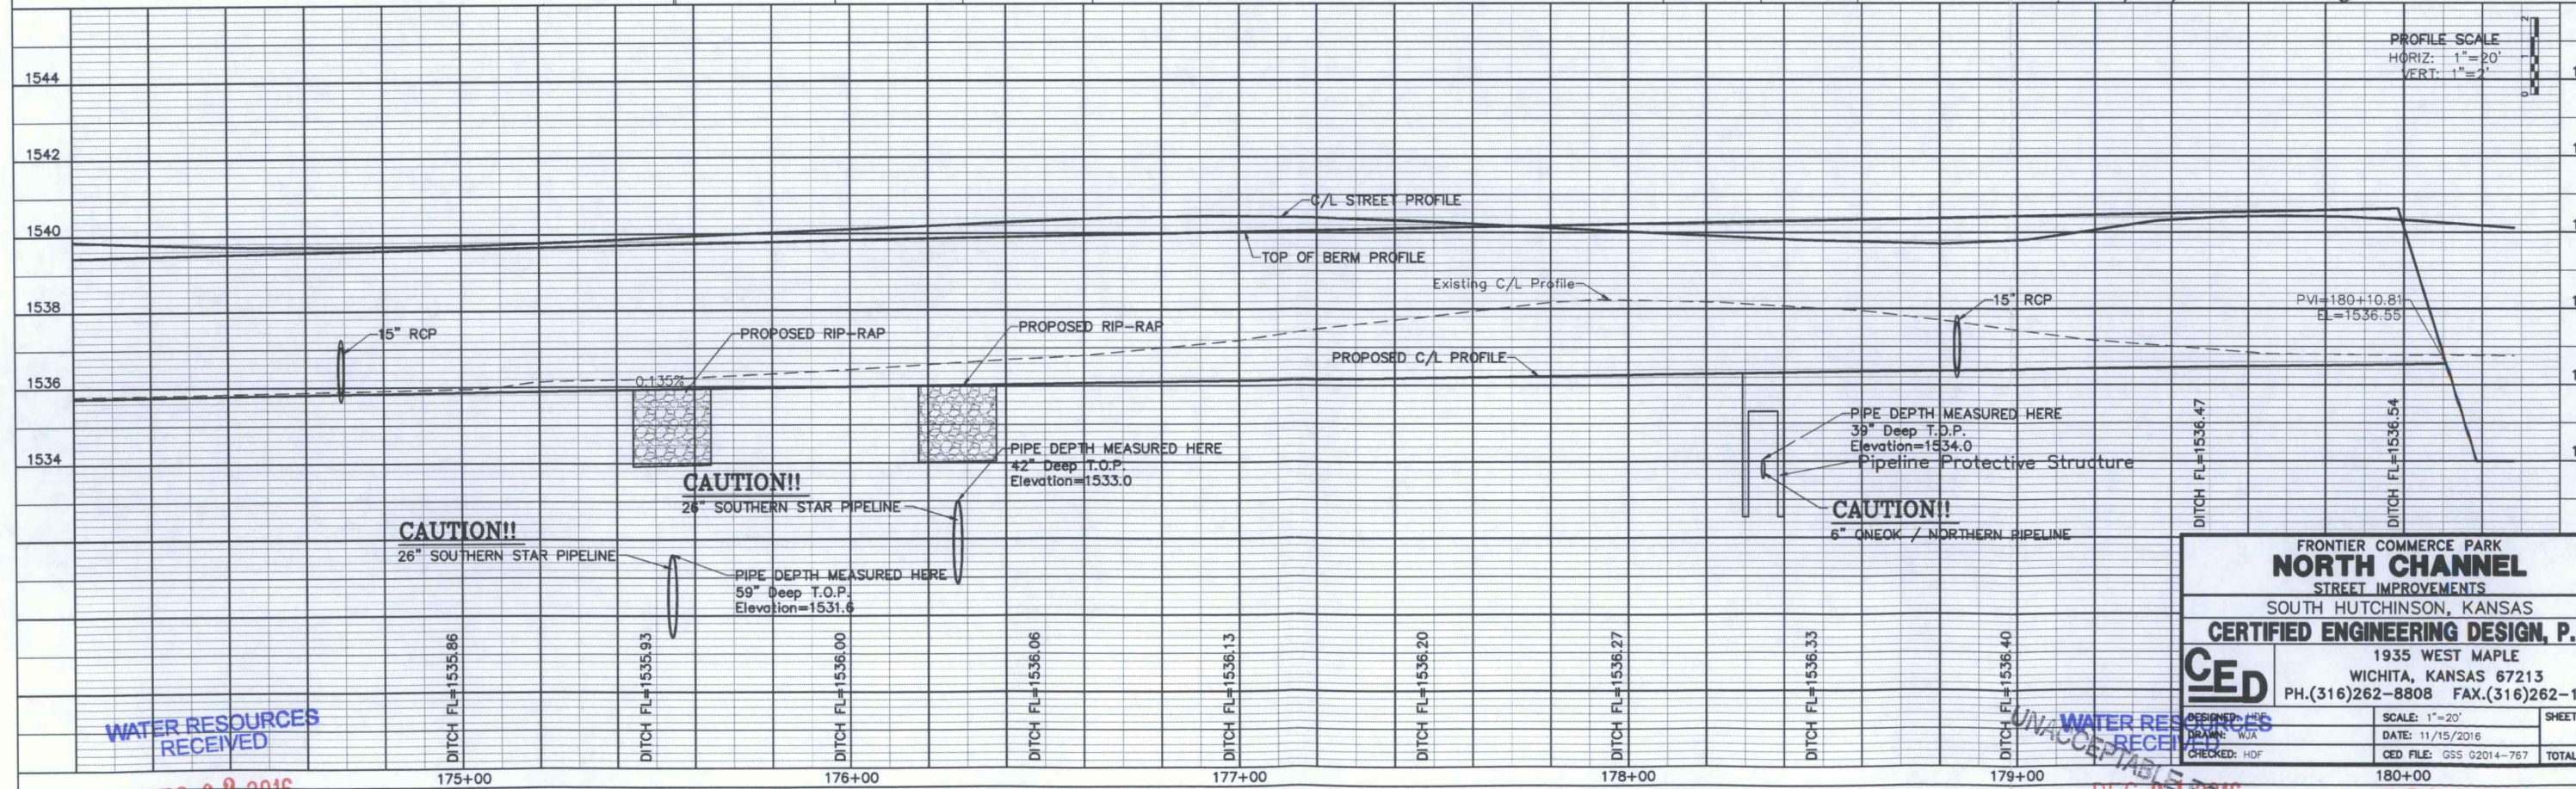

PROFILE SCALE
 HORIZ: 1"=20'
 VERT: 1"=2'

WATER RESOURCES RECEIVED

FRONTIER COMMERCE PARK
NORTH CHANNEL
 STREET IMPROVEMENTS
 SOUTH HUTCHINSON, KANSAS
CERTIFIED ENGINEERING DESIGN, P.
 1935 WEST MAPLE
 WICHITA, KANSAS 67213
 PH.(316)262-8808 FAX.(316)262-1

CED
 DESIGNED: HSE
 DRAWN: WJA
 CHECKED: HOF

SCALE: 1"=20'
 DATE: 11/15/2016
 CED FILE: GSS G2014-767

DESIGNED: HSE
 DRAWN: WJA
 CHECKED: HOF

SHEET TOTAL


DEC 02 2016

DEC 01 2016

KS DEPT OF AGRICULTURE

KS DEPT OF AGRICULTURE

SCANNED

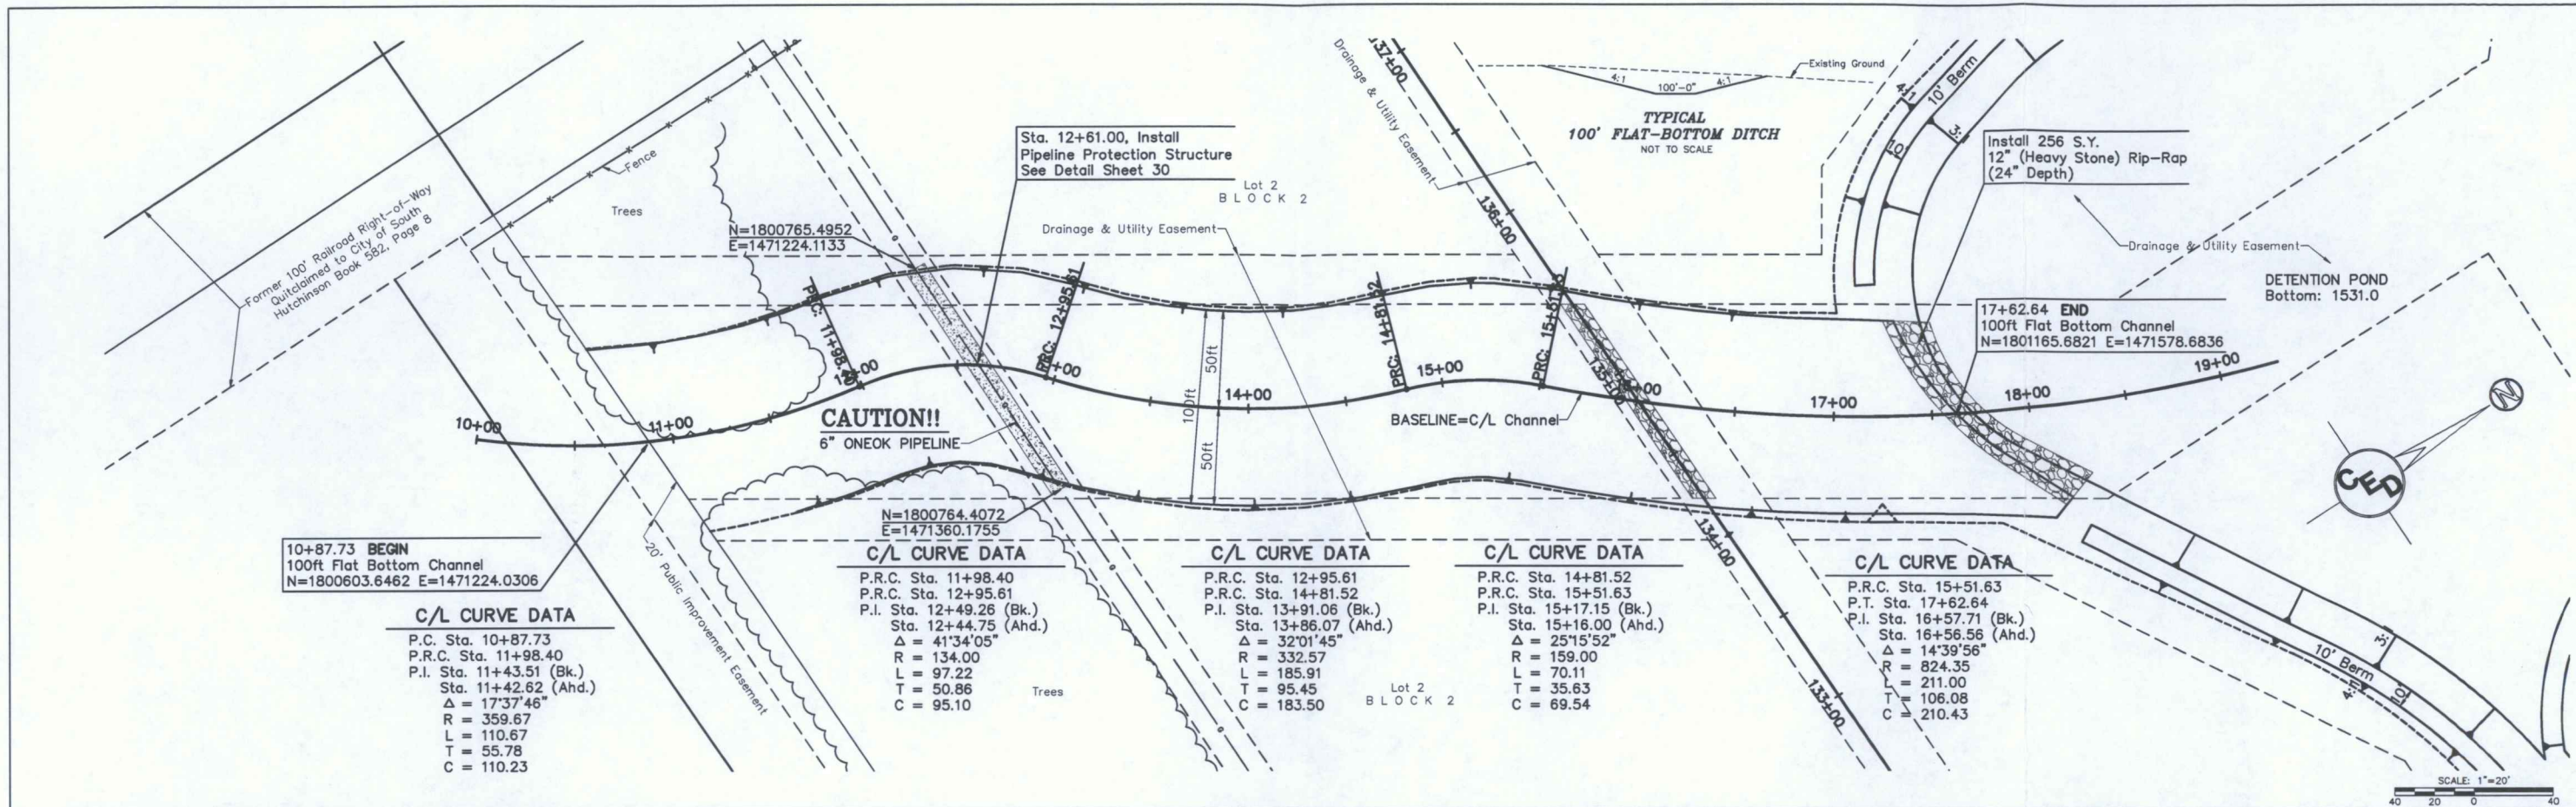

10+87.73 BEGIN
100ft Flat Bottom Channel
N=1800603.6462 E=1471224.0306

C/L CURVE DATA
P.C. Sta. 10+87.73
P.R.C. Sta. 11+98.40
P.I. Sta. 11+43.51 (Bk.)
Sta. 11+42.62 (Ahd.)
Δ = 17°37'46"
R = 359.67
L = 110.67
T = 55.78
C = 110.23

N=1800764.4072
E=1471360.1755


C/L CURVE DATA
P.R.C. Sta. 11+98.40
P.R.C. Sta. 12+95.61
P.I. Sta. 12+49.26 (Bk.)
Sta. 12+44.75 (Ahd.)
Δ = 41°34'05"
R = 134.00
L = 97.22
T = 50.86
C = 95.10

C/L CURVE DATA
P.R.C. Sta. 12+95.61
P.R.C. Sta. 14+81.52
P.I. Sta. 13+91.06 (Bk.)
Sta. 13+86.07 (Ahd.)
Δ = 32°01'45"
R = 332.57
L = 185.91
T = 95.45
C = 183.50

C/L CURVE DATA
P.R.C. Sta. 14+81.52
P.R.C. Sta. 15+51.63
P.I. Sta. 15+17.15 (Bk.)
Sta. 15+16.00 (Ahd.)
Δ = 25°15'52"
R = 159.00
L = 70.11
T = 35.63
C = 69.54

C/L CURVE DATA
P.R.C. Sta. 15+51.63
P.T. Sta. 17+62.64
P.I. Sta. 16+57.71 (Bk.)
Sta. 16+56.56 (Ahd.)
Δ = 14°39'56"
R = 824.35
L = 211.00
T = 106.08
C = 210.43

SCALE: 1"=20'

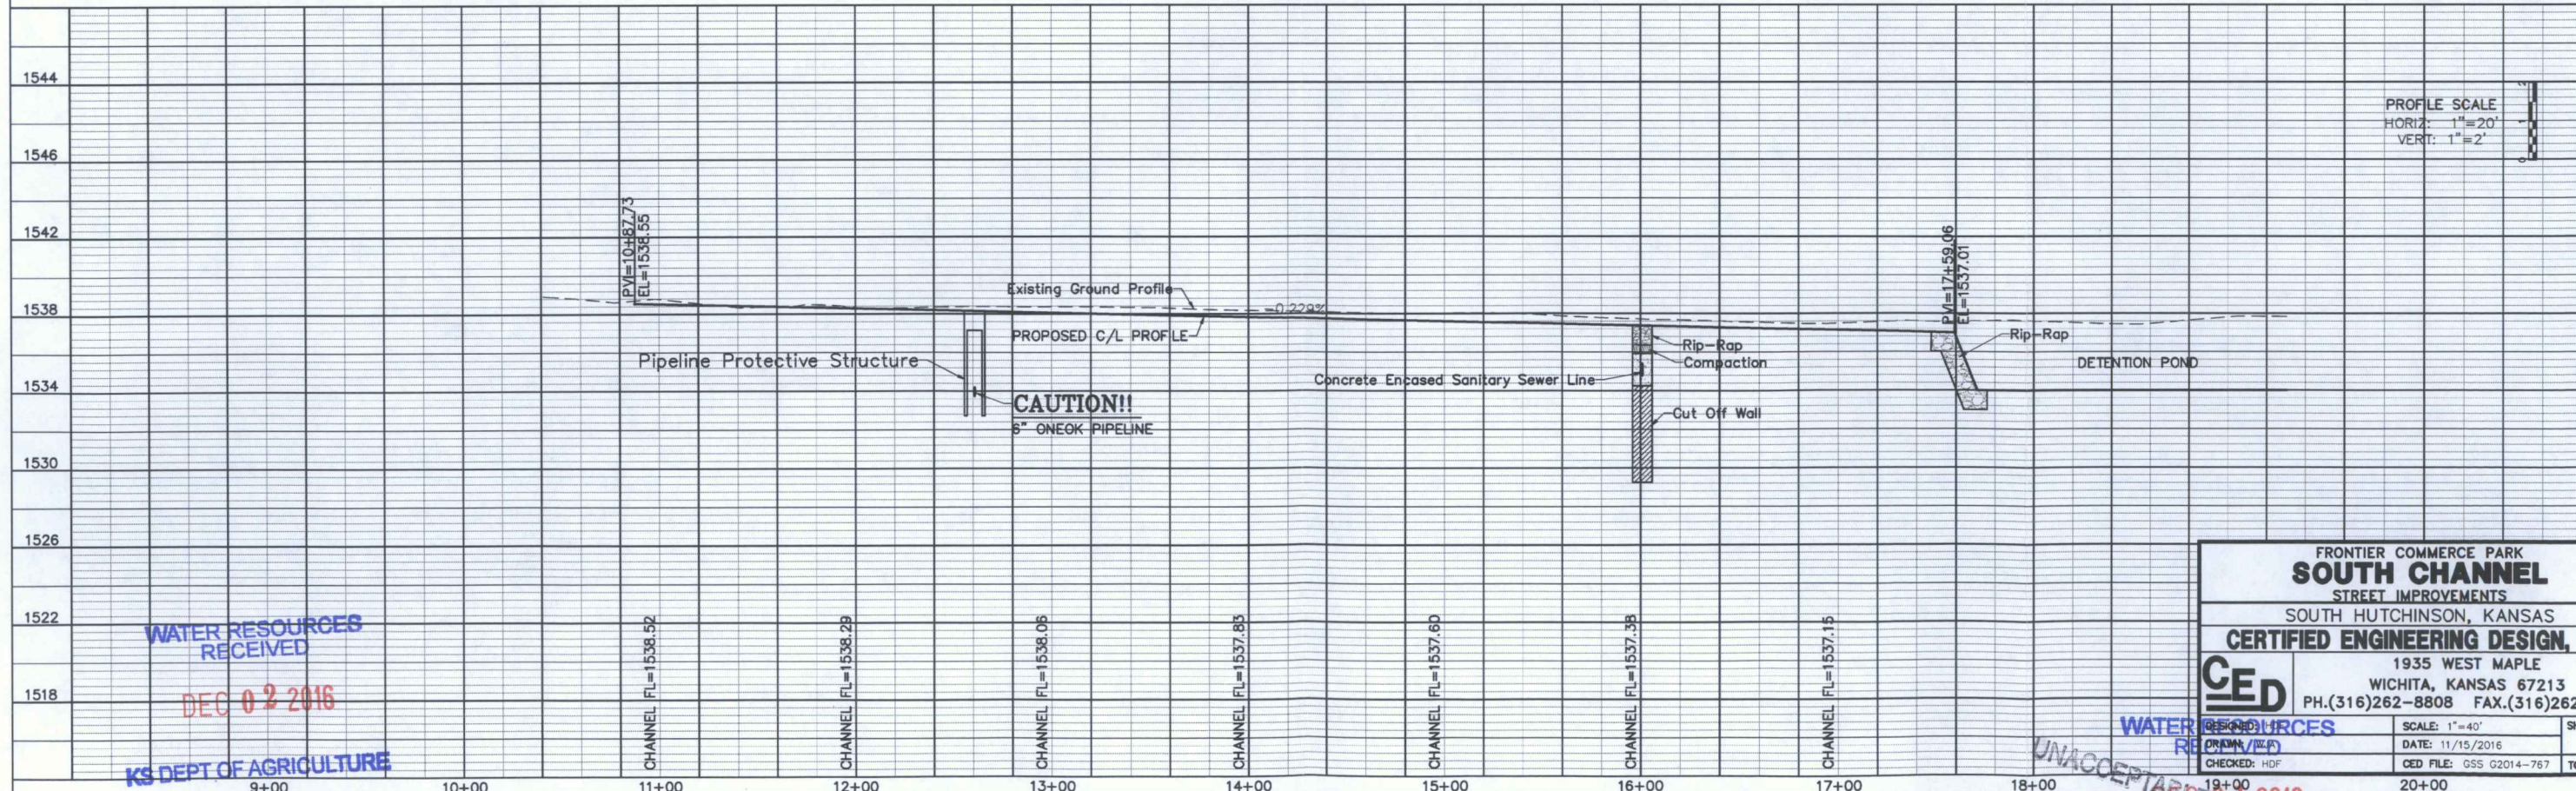

PROFILE SCALE
HORIZ: 1"=20'
VERT: 1"=2'

WATER RESOURCES RECEIVED
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KS DEPT OF AGRICULTURE

FRONTIER COMMERCE PARK
SOUTH CHANNEL
STREET IMPROVEMENTS
SOUTH HUTCHINSON, KANSAS
CERTIFIED ENGINEERING DESIGN, P.E.
1935 WEST MAPLE
WICHITA, KANSAS 67213
PH.(316)262-8808 FAX.(316)262-1


DESIGNER: [Signature]	SCALE: 1"=40'	SHEET
CHECKED: HDF	DATE: 11/15/2016	TOTAL
CED FILE: GSS G2014-767		

UNACCEPTABLE FOR PRIORITY
DEC 01 2016
KS DEPT OF AGRICULTURE




SCANNED

UTILITIES SHOWN REPRESENT THE BEST INFORMATION AVAILABLE FOR DESIGN. ADDITIONAL UTILITIES MAY BE PRESENT ON THIS PROJECT. THE CONTRACTOR SHALL BE RESPONSIBLE FOR DETERMINING THE EXACT LOCATION, DEPTH AND SIZE OF ALL UNDERGROUND UTILITIES PRIOR TO CONSTRUCTION. THE CONTRACTOR SHALL BE LIABLE FOR ANY DAMAGE CAUSED BY THE FAILURE TO DO SO.

DETENTION POND COORD LIST				
Pnt. No.	Northing	Easting	Elevation	Description
100	1801508.67	1471490.24	1540.5	Berm Top
101	1801431.40	1471616.16	1531.0	148ft, Rad. Pt.
102	1801578.40	1471630.94	1540.5	Berm Top
103	1801560.40	1471797.80	1540.5	Berm Top
104	1802072.67	1471835.92	-	514ft, Rad. Pt.
105	1801563.93	1471907.04	1540.5	Berm Top
106	1801580.31	1471996.62	1540.5	Berm Top
107	1801467.87	1472017.31	1531.0	114ft, Rad. Pt.
108	1801551.45	1472095.32	1540.5	Berm Top
109	1801543.16	1472093.37	1536.5	Berm Top
110	1801468.02	1472017.53	1531.0	107ft, Rad. Pt.
111	1801501.80	1472118.80	1536.5	Berm Top
112	1801493.83	1472128.66	1540.5	Berm Top
113	1801453.21	1472130.70	1540.5	Berm Top
114	1801385.28	1472121.82	1540.5	Berm Top
115	1801396.74	1472033.33	1531.0	89ft, Rad. Pt.
116	1801307.66	1472038.37	1540.5	Berm Top
117	1801300.85	1471916.91	1540.5	Berm Top
118	1801002.12	1471933.77	-	299ft, Rad. Pt.
119	1801253.66	1471771.74	1540.5	Berm Top
120	1801191.80	1471664.57	1540.5	Berm Top
121	1801191.94	1471647.46	1538.2	Berm Top
122	1801176.23	1471612.16	1538.2	Berm Top
123	1801322.58	1471547.64	1531.0	160ft, Rad. Pt.
124	1801164.88	1471520.98	1538.2	Berm Top
125	1801167.29	1471500.05	1540.5	Berm Top
126	1801273.45	1471561.10	1531.0	122ft, Rad. Pt.
127	1801241.63	1471442.84	1540.5	Berm Top
128	1801274.03	1471434.53	1540.5	Berm Top
129	1801333.98	1471683.82	1531.0	256ft, Rad. Pt.
130	1801471.33	1471467.32	1540.5	Berm Top

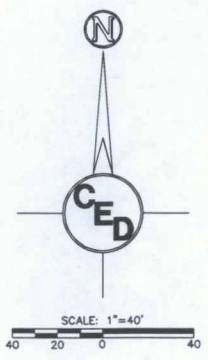

- POND CONSTRUCTION SEQUENCE
- Pond Bottom and side slopes below static water elevation shall be over-excavated 1' and a 1' clay liner installed and compacted to 95% std. Density in 2-6" Lifts. The plasticity index shall be at least 30. The compaction and P.I. shall be verified during construction. P.I. determination and compaction testing shall be arranged by the contractor at the request of the inspector. Cost shall be subsidiary to "Clay Liner Construction". Estimated liner is 7191 C.Y.'s.
Ground water control, if required for completion of excavation, is subsidiary to "Clay Liner Construction".
 - All Reserves above the static water elevation shall be seeded and mulched as follows: (Permanent Seeding)
SEED: Kansas Premium Fescue Blend, 8#/1000 Sq. Ft.
FERTILIZER: 12-24-12 Ratio @ 350 Lbs./Acre
MULCH: Prairie Hay, 2 Tons/Acre
 - Contractor to strip top 6" of soil before mass grading and stockpile. Top soil stockpile to be redistributed over entire disturbed area excluding street right-of-way and ponds to achieve planned grade.

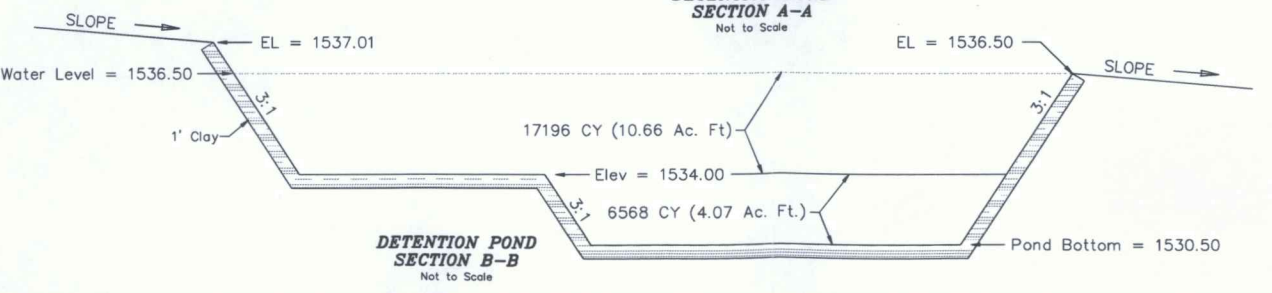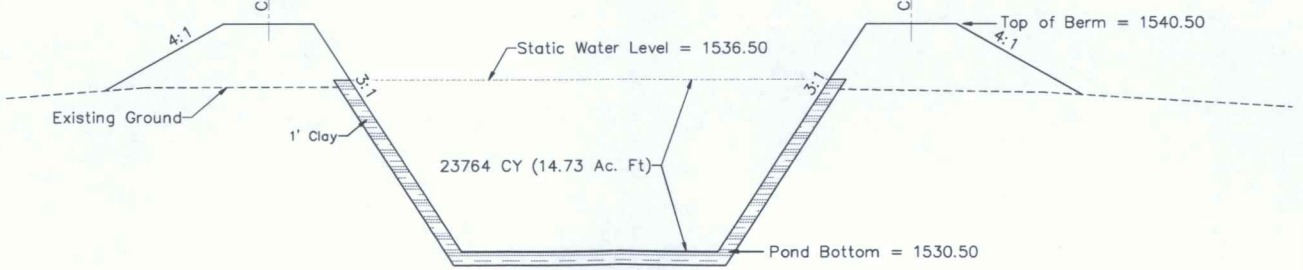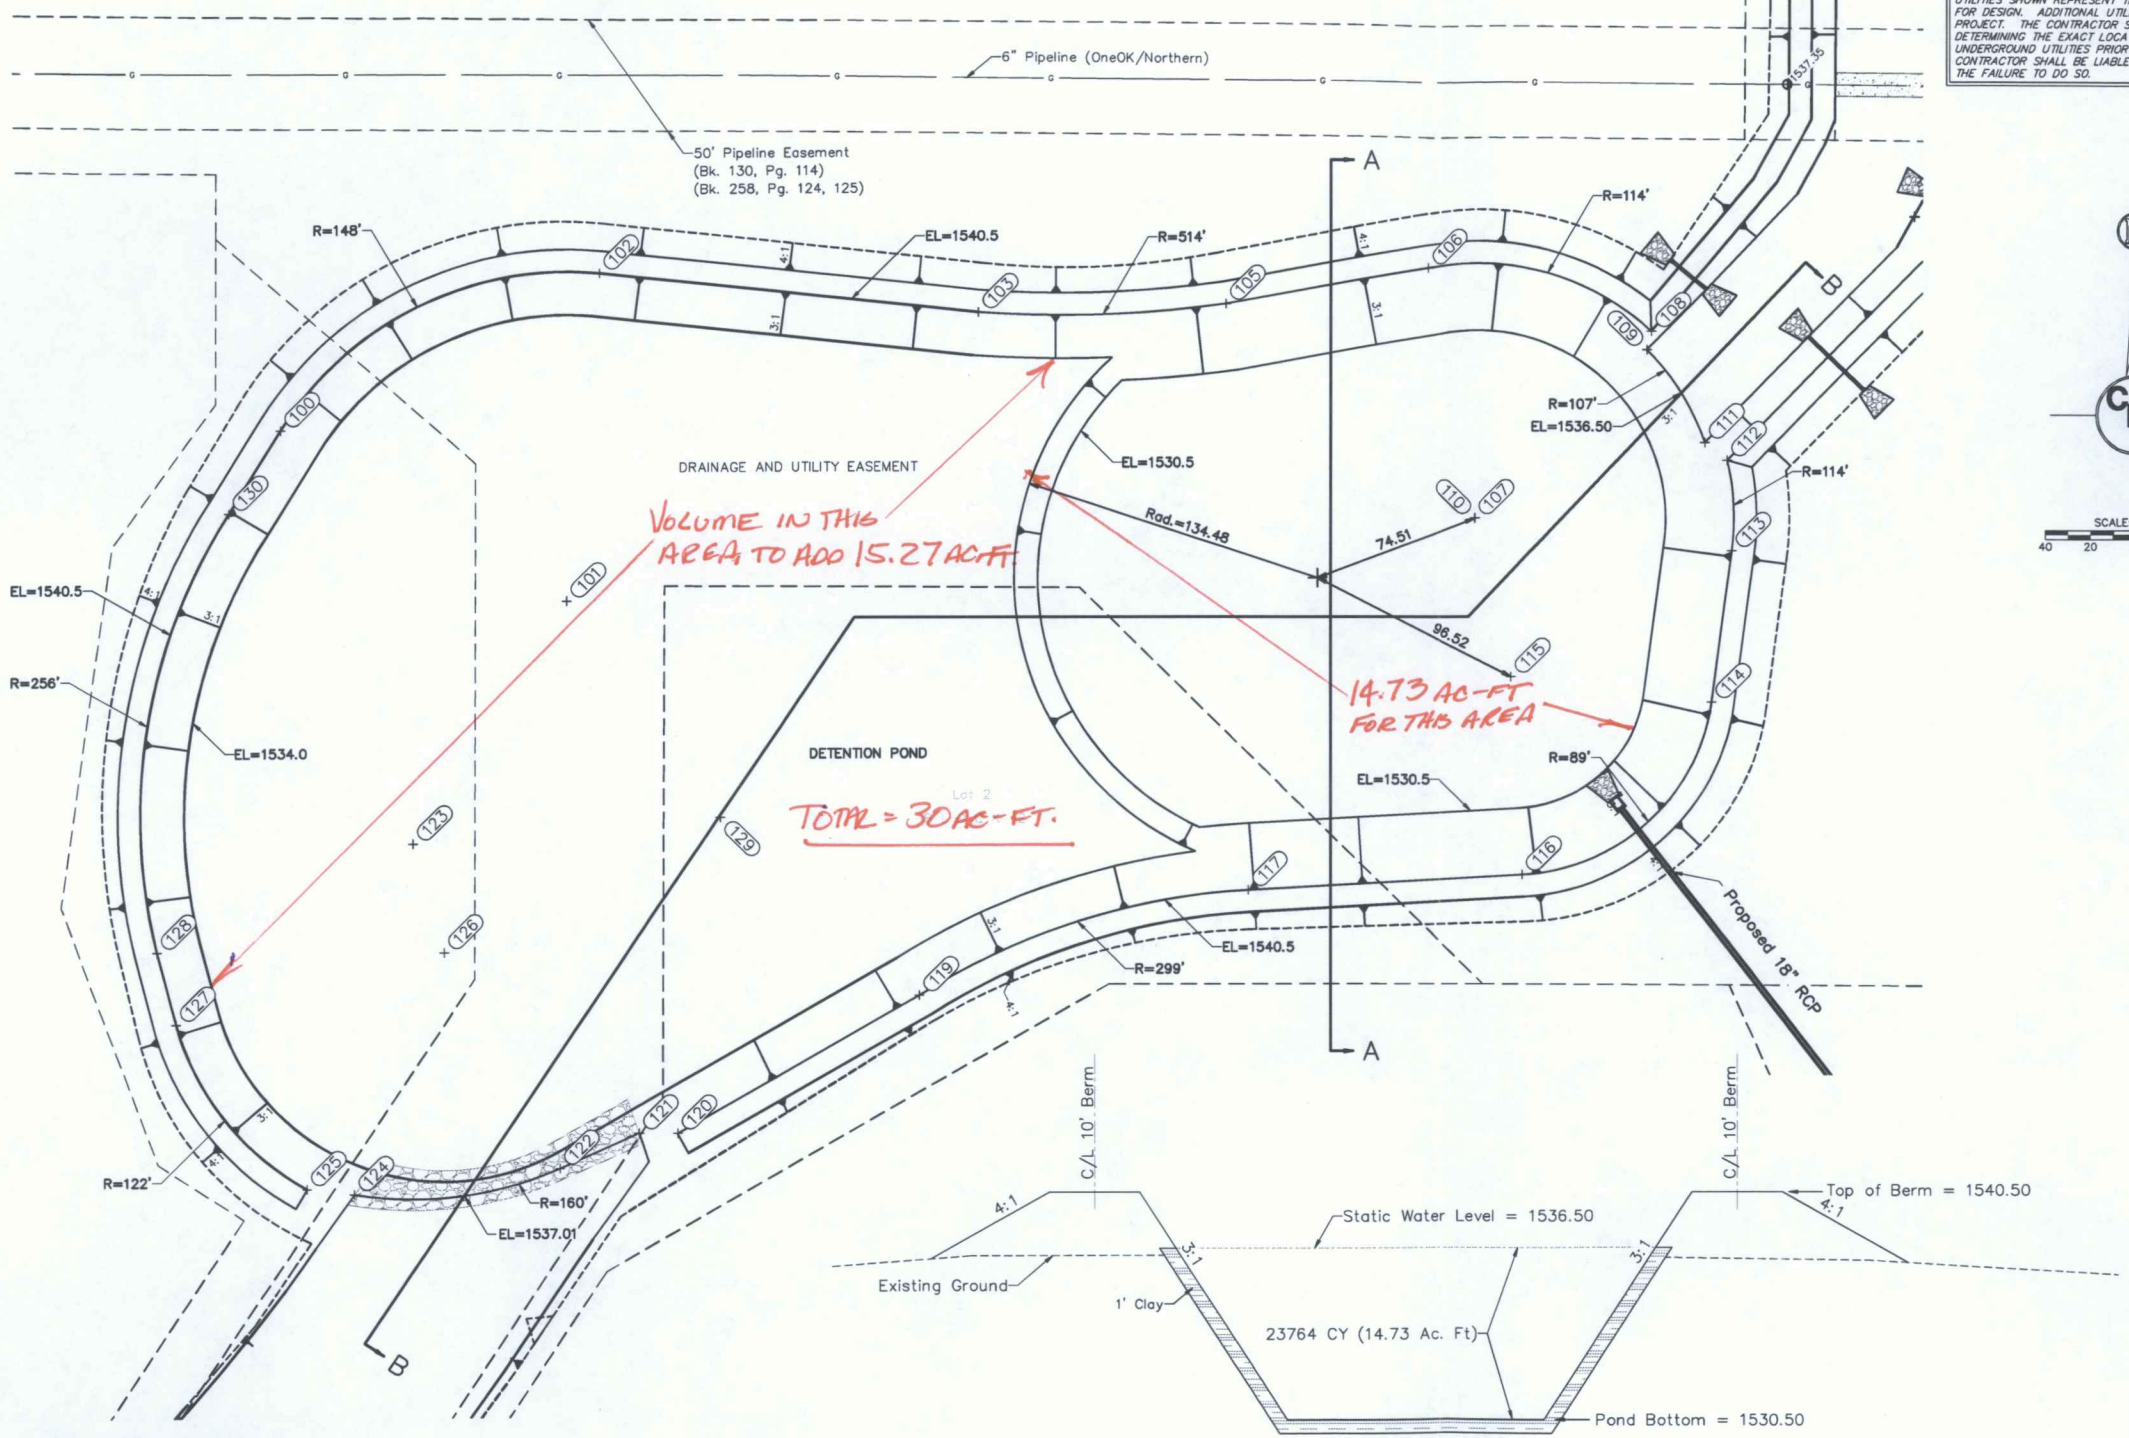

VERTICAL AND HORIZONTAL PROJECT CONTROL:
 N=1798070.7750 E=1470973.5000
 USGS Azimuth Mark disk set in concrete post stamped "Fair Az Mk" located 27 feet North of the centerline of West Morgan Avenue approximately 1/2 mile West of K-61 and 50 feet West of the former AT&SF railroad (now vacated & razed). Elevation=1546.73 (NAVD88)
 SBM #1 N=1801078.7487 E=1473213.7076
 Square cut on the Southwest corner of a concrete pad for an electric box that is 163ft west of the entrance to Heartland Outdoor Store. Elevation=1538.65 (NAVD88)
 SBM #2 N=1801844.4099 E=1472976.1589
 Blue capped rebar in concrete 167ft West and 84ft North of the Northeast corner of the Conoco Plaza Go truck parking lot. Elevation=1540.26 (NAVD88)
 SBM #3 N=1800795.5278 E=1473105.4049
 Blue capped rebar in concrete 205 feet East of the Southwest corner of the Heartland Outdoor concrete parking lot. Elevation=1537.11 (NAVD88)




**FRONTIER COMMERCE PARK
 PROPOSED POND
 STREET IMPROVEMENTS**
 SOUTH HUTCHINSON, KANSAS
CERTIFIED ENGINEERING DESIGN, P.E.
 1935 WEST MAPLE
 WICHITA, KANSAS 67213
 PH.(316)262-8808 FAX.(316)262-1

WATER RESOURCES RECEIVED
WACCEP DEC 01 2016
FOR PRIORITY

DESIGNED: HDF	SCALE: 1"=40'	SHEET
DRAWN: WJA/JAK	DATE: 11/15/2016	TOTAL
CHECKED: HDF	CD FILE: G55 G2014-767	

DEC 02 2016
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 SCANNED

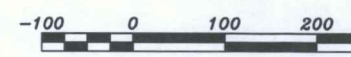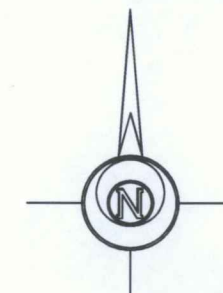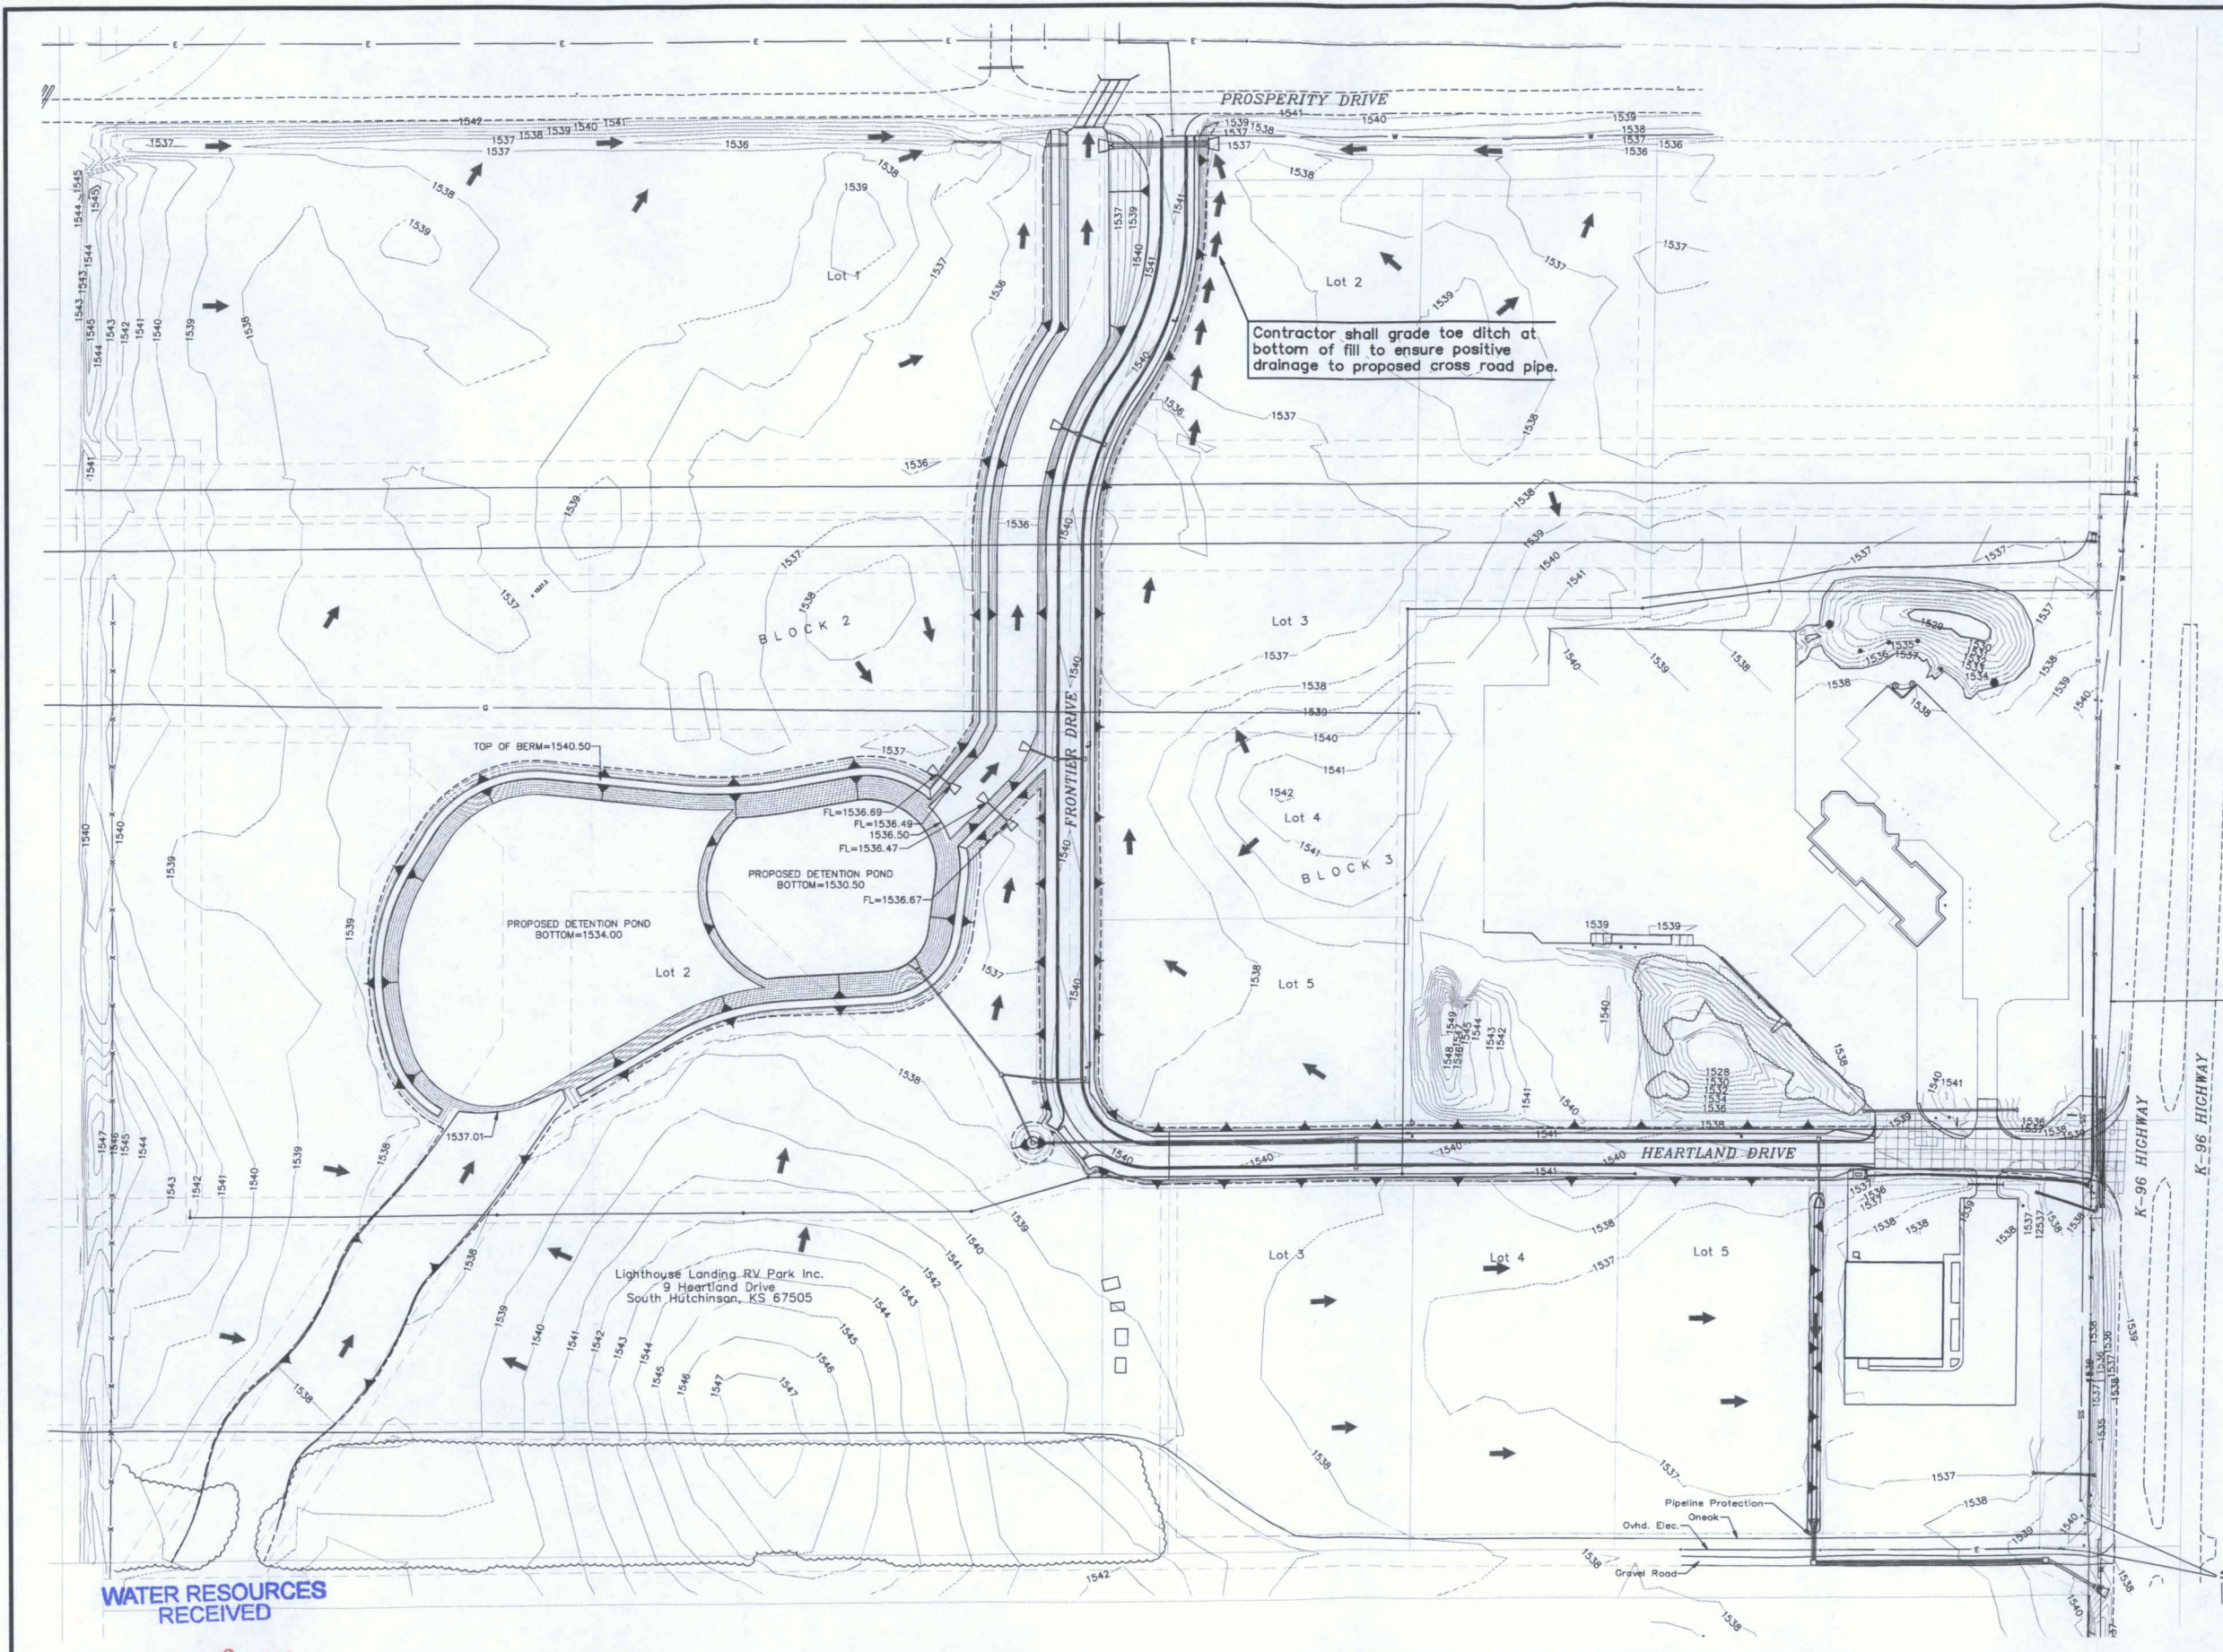

WATER RESOURCES RECEIVED

DEC 02 2016

KS DEPT. OF AGRICULTURE

UNACCEPTABLE FOR PROJECT
 WATER RESOURCES RECEIVED
 DEC 01 2016
 KS DEPT OF AGRICULTURE

FRONTIER COMMERCE PARK PROJECT CONTOUR STREET IMPROVEMENTS SOUTH HUTCHINSON, KANSAS	
CERTIFIED ENGINEERING DESIGN	
1935 WEST MAPLE WICHITA, KANSAS 67 PH.(316)262-8808 FAX.(316)262-8809	
DESIGNED: HDF	SCALE: 1"=100'
DRAWN: WJA	DATE: 11/15/2016
CHECKED: HDF	CED FILE: GSS G2014-7

SCANNED